

Indiana Department of Environmental Management Office of Water Quality Wetlands Section

Publication Date: July 10, 2024

PUBLIC NOTICE

IDEM ID Number: 2024-494-2-ENH-A

Corps of Engineers ID Number: LRE-2024-00087-102-A24

Closing Date: July 31, 2024

To all interested parties:

This letter shall serve as a formal notice of the receipt of an application for **Section 401 Water Quality Certification** by the Indiana Department of Environmental Management (IDEM). The purpose of the notice is to inform the public of active applications submitted for water quality certification under Section 401 of the Clean Water Act (33 U.S.C. § 1341) and to solicit comments and information on any impacts to water quality related to the proposed project. IDEM will evaluate whether the project complies with Indiana's water quality standards as set forth at 327 IAC 2.

1. Applicant: City of Fort Wayne

Attn: Anne Marie Smrchek 200 East Berry Street, Suite 425

Fort Wayne, IN 46802

2. Agent: Christopher B. Burke Engineering, LLC

Attn: Marin Miller

115 West Washington Street, Suite 1368 S

Indianapolis, IN 46204

3. Project location: Spy Run Creek, South Dam, Fort Wayne, Allen County

Latitude 41.089308, Longitude -85.135831

4. Affected waterbody: Spy Run Creek

5. Project Description: The project involves removing the south low-head dam on Spy Run Creek via: constructing a temporary access

road to the site; constructing a temporary causeway; removing the existing low-head dam; removing the temporary access road and temporary causeway; and implementing erosion and sediment control. The

aforementioned activities will result in up to 460 cubic yards / 0.07 acres of temporary fill in Spy Run Creek. The

deteriorating dam is claimed to be obsolete and having exceeded its useful design life. Additional information may be found online at https://www.in.gov/idem/5474.htm

Comment period: Any person or entity who wishes to submit comments or information relevant to the aforementioned project may

do so by the closing date noted above. Only comments or information related to water quality or potential impacts of the project on water quality can be considered by IDEM in the water quality certification review

process.

Public Hearing: Any person may submit a written request that a public hearing be held to consider issues related to water quality

in connection with the project detailed in this notice. The request for a hearing should be submitted within the comment period to be considered timely. The request should also state the reason for the public hearing as

specifically as possible to assist IDEM in determining whether a public hearing is warranted.

Questions? Additional information may be obtained from Emersyn Harriman, Project Manager, by phone at 317-409-7580 or

by e-mail at eharrima@idem.in.gov. Please address all correspondence to the project manager and reference the IDEM project identification number listed on this notice. Indicate if you wish to receive a copy of IDEM's final

decision. Written comments and inquiries may be forwarded to -

Indiana Department of Environmental Management

100 North Senate Avenue MC65-42 WQS IGCN 1255

Indianapolis, Indiana 46204-2251 FAX: 317/232-8406

FORT WAYNE CITY UTILITIES ENGINEERING

SPY RUN CREEK DAM REMOVAL

MAYOR

HONORABLE SHARON TUCKER


BOARD OF PUBLIC WORKS


SHAN GUNAWARDENA, CHAIRMAN KUMAR MENON, MEMBER CHRIS GUERRERO, MEMBER


CITY UTILITES ENGINEERING

MATTHEW A. WIRTZ, P.E.
DEPUTY DIRECTOR/CHIEF ENGINEER
NATHAN BAGGETT, P.E.
BENJAMIN GENSIC, P.E.

PROJECT MANAGERS

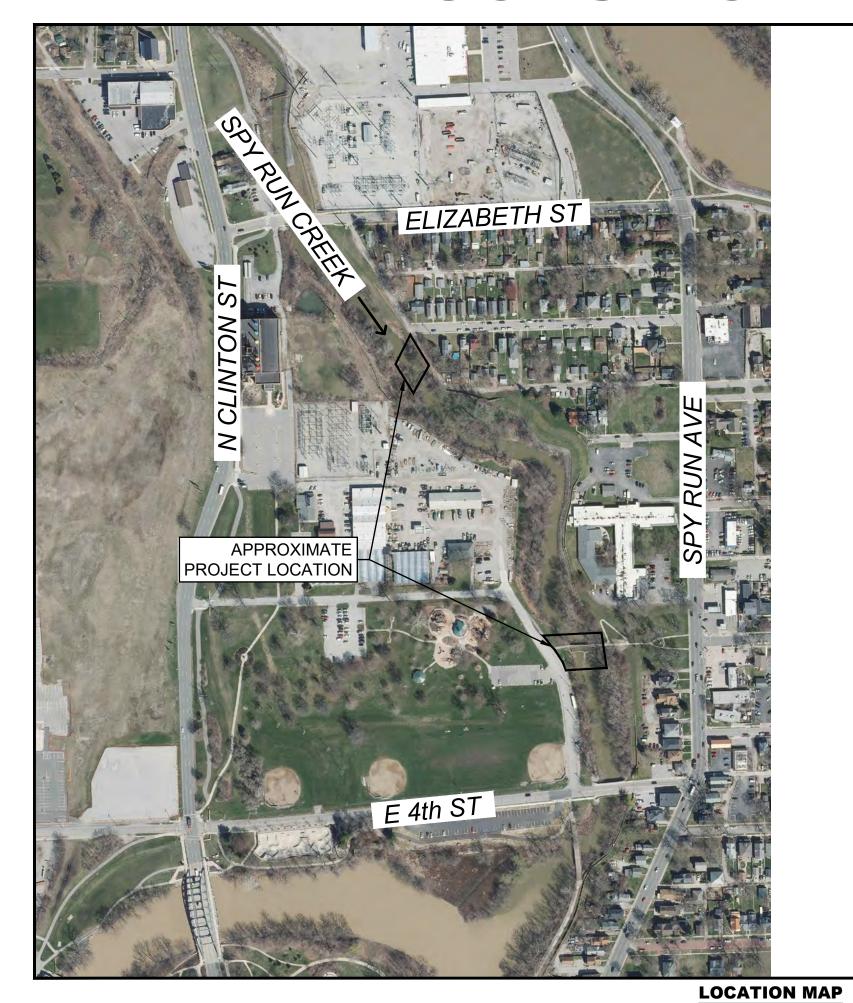

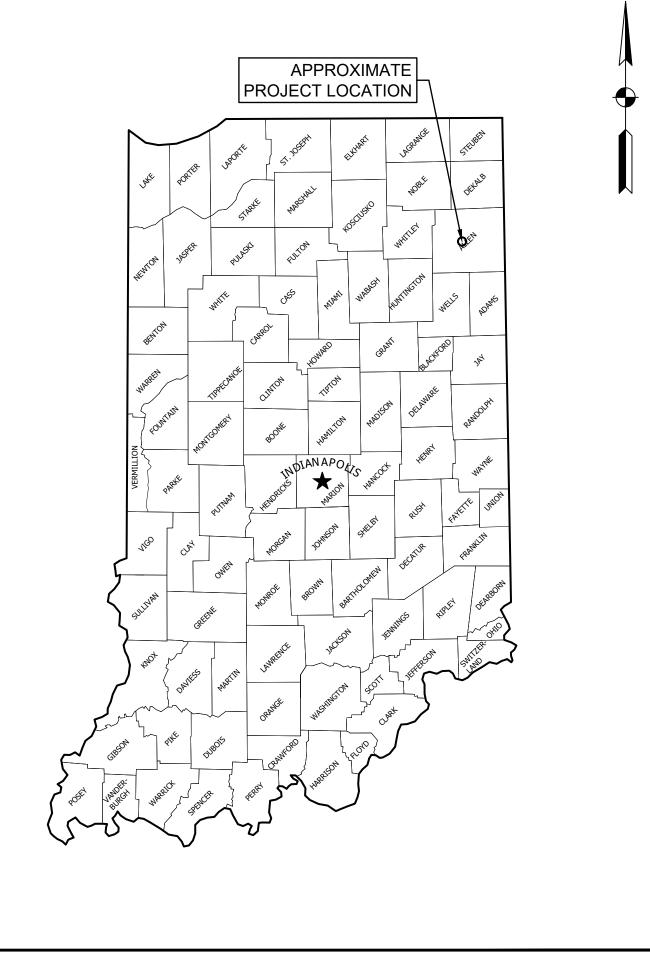

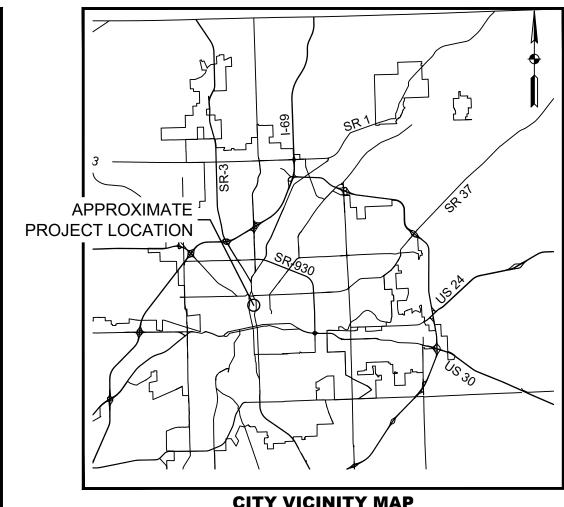

CITY VICINITY MAP
Scale: N.T.S.

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NO.	ID NO.	DESCRIPTION	REMARKS							
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4	G-003-004	DOWNSTREAM DAM EXISTING PLAN AND SECTION								
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10	C-201-010	EROSION CONTROL PLAN DETAILS								

REMARKS									
	W.O. NO: 83947								
	DWG NO: ##-####								
	SURVEYED BY: APEX								
	CONSULTING&SURVEYING								
	DRAWN BY: ABBY R. PETERSON, P.E.								
	DESIGNED BY: AARON J. FRICKE, P.E.								
	CHECKED BY:								

APPROVED BY:

APPROVED BY:

AARON J. FRICKE, P.E.

SHEET TITLE:

TITLEG-001-001

SHEET 1 OF 10



RESOLUTION NO. 83947

0 150 300

THE PURPOSE OF THIS PROJECT IS TO REMOVE TWO LOW-HEAD DAMS ON SPY RUN CREEK IN FORT WAYNE, INDIANA.

THE SCOPE OF WORK INCLUDES THE FOLLOWING:

1. CONSTRUCTING TEMPORARY ACCESS ROAD(S) TO THE UPSTREAM DAM

2. CONSTRUCTING TEMPORARY CAUSEWAY(S) (OPTIONAL)

4. REMOVING THE TEMPORARY ACCESS ROAD(S) AND TEMPORARY CAUSEWAY 5. EROSION AND SEDIMENT CONTROL

3. REMOVING THE EXISTING LOW-HEAD DAMS

SURVEY NOTES

TOPOGRAPHIC SURVEY PROVIDER: APEX CONSULTING & SURVEYING, INC.

1313 BROADWAY FORT WAYNE, INDIANA 46802

REFER TO TOPOGRAPHIC SURVEY SHEET FOR BENCHMARK AND CONTROL INFROMATION. VERTICAL DATUM IS NAVD88.

REGULATORY NOTES

- 1. OWNER HAS OR WILL OBTAIN THE FOLLOWING PERMITS FOR THIS PROJECT:
- CERTIFICATE OF APPROVAL OF CONSTRUCTION IN A FLOODWAY FROM THE INDIANA DEPARTMENT OF NATURAL
- SECTION 401 WATER QUALITY CERTIFICATION FROM THE INDIANA DEPARTMENT OF ENVIRONMENTAL
- SECTION 404 DEPARTMENT OF THE ARMY PERMIT FROM THE UNITED STATES ARMY CORPS OF ENGINEERS
- SECTION 408 PERMIT FROM THE UNITED STATES ARMY CORPS OF ENGINEERS
- 2. CONTRACTOR IS RESPONSIBLE FOR COMPLIANCE WITH PERMIT CONDITIONS. 3. CONTRACTOR IS RESPONSIBLE FOR OBTAINING ALL OTHER PERMITS AS REQUIRED.

UTILITY NOTES

- 1. UTILITIES SHOWN ON THE DRAWINGS ARE BASED ON TOPOGRAPHIC SURVEY AND SHOULD BE CONSIDERED FOR REFERENCE ONLY.
- 2. CALL INDIANA 811 AT LEAST 48 HOURS PRIOR TO COMMENCEMENT OF LAND-DISTURBING ACTIVITIES TO SCHEDULE
- A UTILITY LOCATE. ALL UNDERGROUND UTILITIES SHALL BE FLAGGED OR CLEARLY MARKED. 3. VERIFY THE LOCATION OF ALL EXISTING UTILITIES AND REPORT ANY DISCREPANCIES OR OMISSIONS WITH THE
- EXISTING UTILITIES SHOWN ON THE DRAWINGS TO ENGINEER IMMEDIATELY. 4. COORDINATE WITH UTILITY COMPANIES WITHIN AND ADJACENT TO PROJECT LIMITS PRIOR TO COMMENCING WORK
- 5. PROTECT EXISTING UTILITIES IN AN APPROPRIATE MANNER AS REQUIRED TO PREVENT DAMAGE.
- 6. ALL UTILITIES MUST BE FULLY OPERATIONAL AND ACCESSIBLE THROUGHOUT THE DURATION OF THE PROJECT. IF IT IS NECESSARY TO DISRUPT SERVICE, NOTIFY ENGINEEER AND UTILITY COMPANY AT LEAST 48 HOURS IN ADVANCE OF THE PLANNED INTERRUPTION TO COORDINATE REQUIREMENTS.


RIGHT-OF-WAY NOTES

- 1. CONTRACTOR IS RESPONSIBLE FOR OBTAINING A LOCAL PERMIT FOR WORK WITHIN THE RIGHT-OF-WAY, IF REQUIRED. CONTRACTOR MUST MEET REQUIREMENTS FOR INSURANCE AND BONDING.
- 2. CONTRACTOR SHALL SUBMIT A MAINTENANCE OF TRAFFIC PLAN FOR APPROVAL. COORDINATE WITH THE CITY OF FORT WAYNE FOR REQUIREMENTS.

FLOOD ZONE MAP



UPSTREAM DAM ACCESS MAP

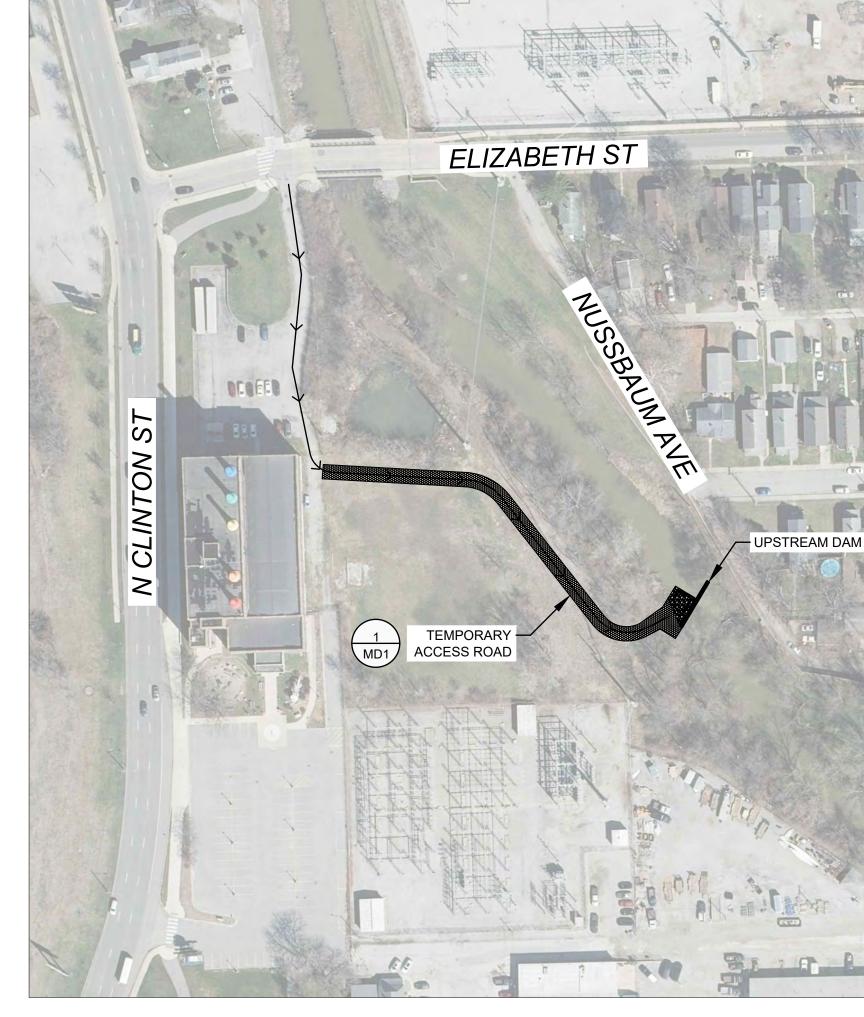

ACCESS NOTES

- 1. APPROXIMATE ACCESS ROUTE SHOWN. COORDINATE WITH OWNER TO ESTABLISH EXACT ACCESS ROUTE IN FIELD.
- 2. REMOVE TEMPORARY ACCESS ROAD FOLLOWING CONSTRUCTION.

3. SEED AND STRAW MULCH DISTURBED AREAS FOLLOWING REMOVAL.

PHOTO 1



PHOTO TAKEN ON 02/16/2024 LOOKING UPSTREAM AT DOWNSTREAM DAM FROM EAST BANK

PHOTO 2



PHOTO TAKEN ON 02/16/2024 ON CREST OF DOWNSTREAM DAM, LOOKING WEST

PHOTO 3



PHOTO TAKEN ON 02/16/2024 LOOKING UPSTREAM AT UPSTREAM DAM FROM EAST BANK

PHOTO 4



PHOTO TAKEN ON 02/16/2024 ON CREST OF UPSTREAM DAM, LOOKING EAST

83947 W.O. NO: DWG NO: ##-#### SURVEYED BY: APEX

DRAWN BY: ABBY R. PETERSON, P.E. DESIGNED BY:

CONSULTING&SURVEYING


AARON J. FRICKE, P.E. CHECKED BY: JEFFREY D. FOX, P.E.

APPROVED BY: AARON J. FRICKE, P.E. DATE:

SHEET TITLE:

PROJECT INFORMATION SHEET

G-002-002 SHEET 2 OF 10

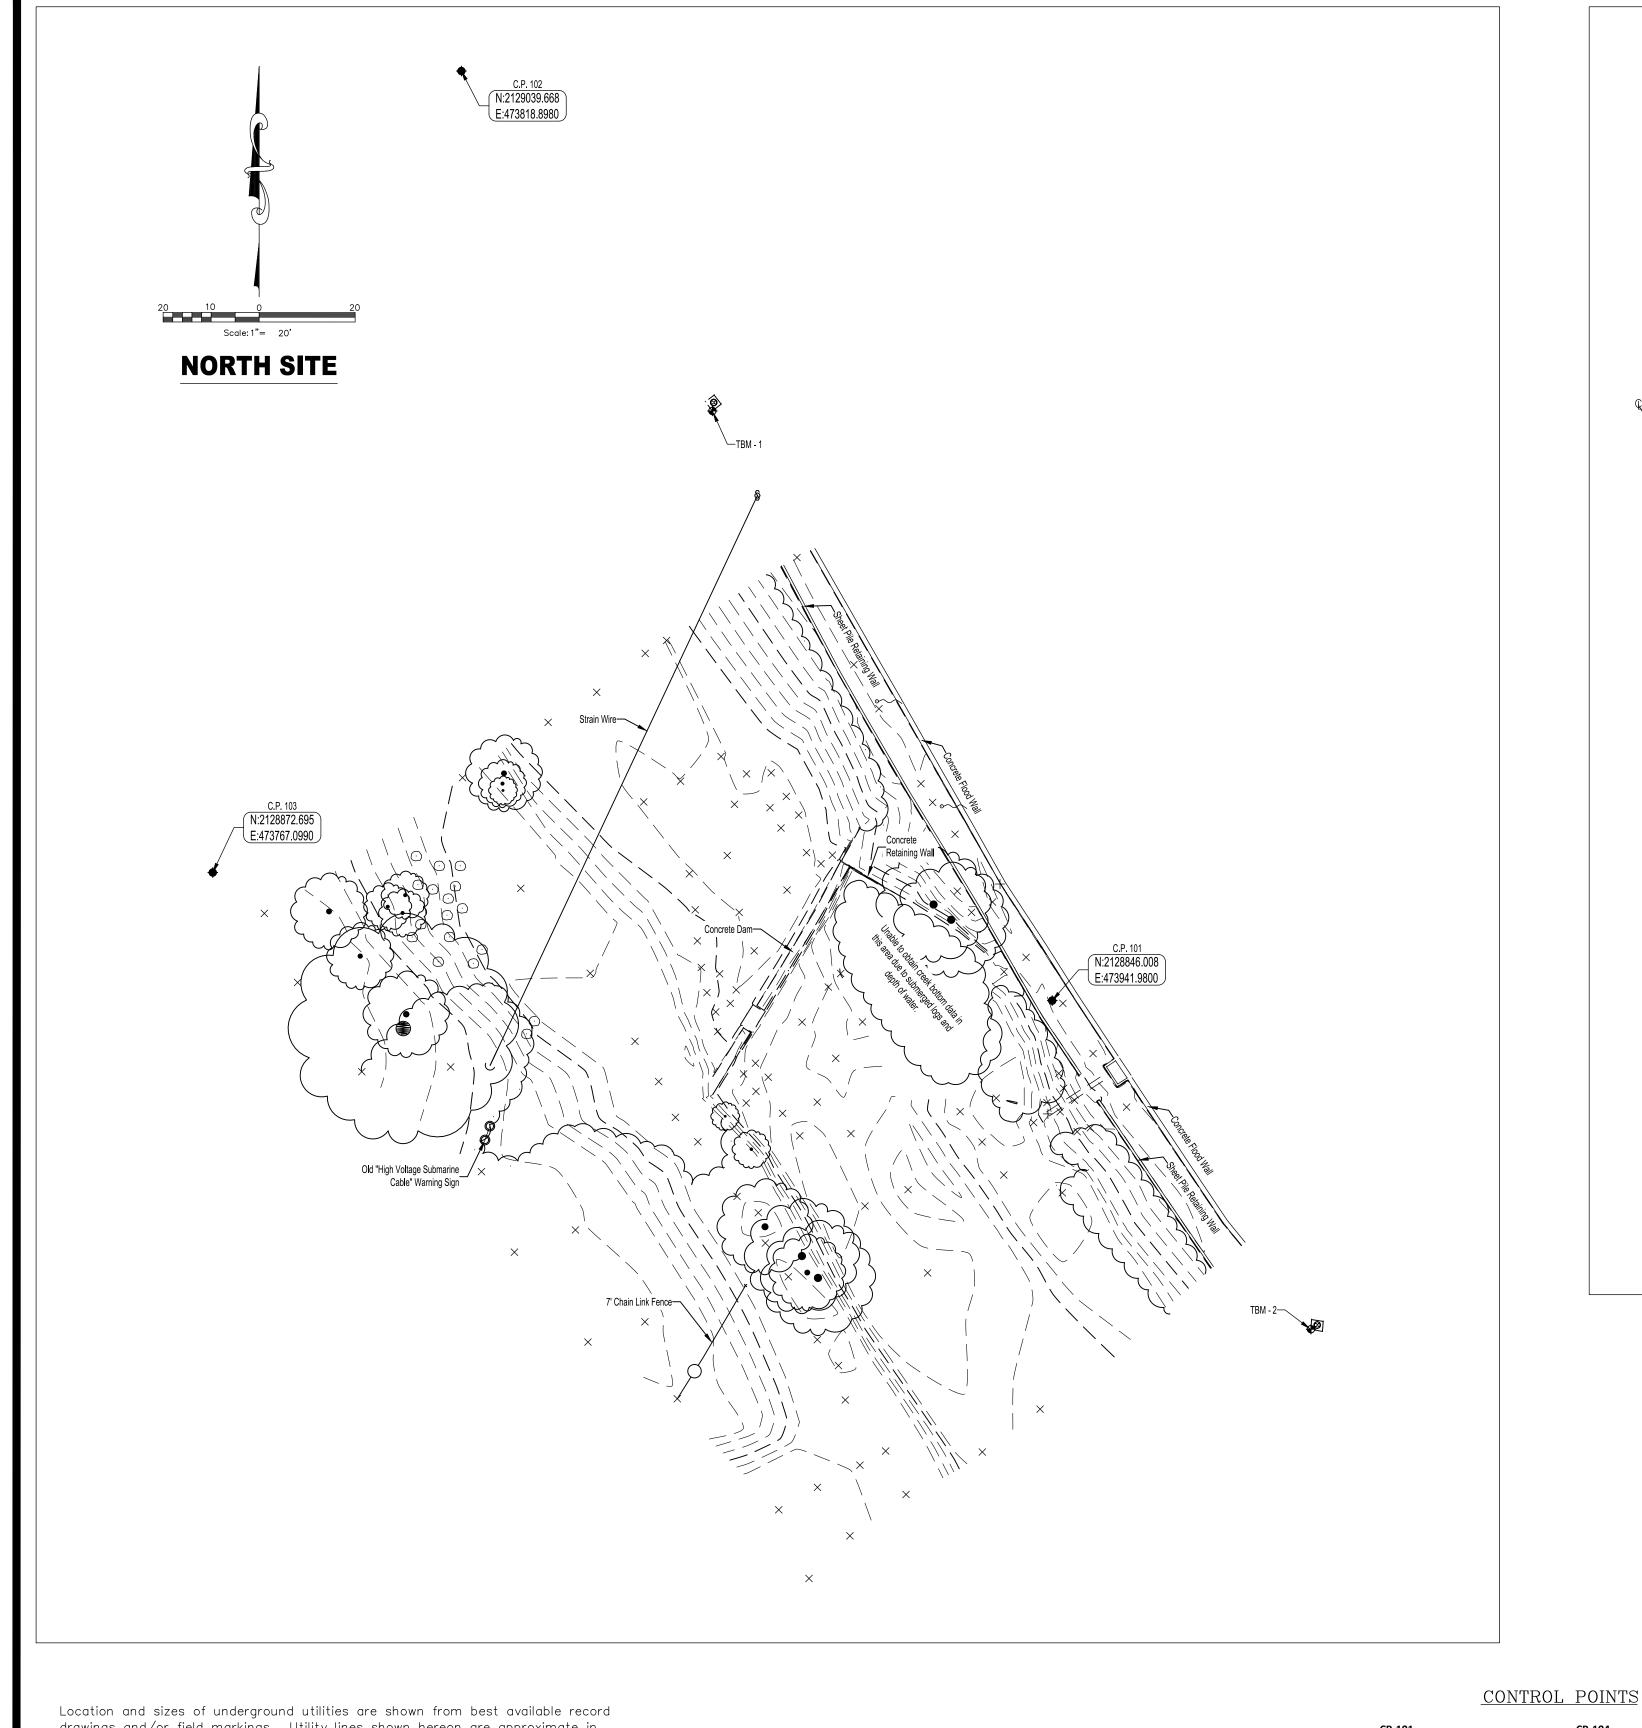

SOUTH SITE Symbols Legend

> ELECTRIC AEP

1501 Hale Ave. Fort Wayne, IN 46802 Contact: Dave Schaafsma utilitycoordination@nisource.com WATER, SEWER & TRAFFIC LIGHTS City of Fort Wayne 200 E. Berry St., Suite 210 Fort Wayne, IN 46802

260-427-2696 Mario.trevino@cityoffortwayne.org

AT&T TRANSMISSION 222 W. Jackson St. Woodstock, IL 60098 Contact: Kenneth Colwell 312-734-2223 Kc1298@att.com

J. Jay Marlow

TELEPHONE

Frontier

260-408-3447

8001 W. Jefferson Blvd.

Fort Wayne, IN 46804

Contact: Mark Winters

INDIANA 811 TICKET NUMBERS

🖂 Air Conditioning Unit 🦉 Power Pole w/ Elec. Drop 📵 Iron Pin

8 Sanitary Tap

<u>UTILITY CONTACTS</u> GAS NIPSCO

Contact: Mario Trevino

260-413-0986 mark.winters@ftr.com FIBER OPTIC


CABLE TV Comcast 720 Taylor St. Fort Wayne, IN 46802 Contact: John Gayday 260-458-5107 john_gayday@cable.comcast.com

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凶	Antenna	E	Electric Box	W	Mag Nail	•	Stump
\otimes	Axle Shaft	E	Electric Meter	MB	Mailbox	0	Survey Marker Nail
•	Bench Mark		Electric Panel	(0)	Manhole	•	T-Bar Post
€	Bollard	區	Electric Pedestal	ö	Monitoring Well	•	Temporary Bench Mark
0	Bolt		Electric Transformer	*	Pine Tree	T	Telephone Pedestal
\odot	Boulder	0	Light Pole Base Only	PAY	Pay Phone	ф	Telephone Pole
\triangle	Cable TV Pedestal	□ —> (Light Pole	PB	Paper Box	(\cdot)	Tree
8	Clean—Out		Yard Light		Parking Block		Vault
•	Column	$\dot{\Box}$	Power Pole	PM	Parking Meter	ô	Automatic Sprinkler
•	Control Point	§	Strain Pole	\otimes	Boundary Mon Pipe	ä	Irrigation Control Valve
	Drain	\Diamond	Finish Floor	Ø	Chiseled "X"	×	Fire Hydrant
•	B-Hive Inlet	~~	Flag	®	PK Nail	Ø	Water Curb Stop
	Square Inlet	×	Ground Shot	0	Post	00	Well
⊞	Curb Cast Inlet	GAS	Gas Regulator	I	l Beam Post		Water Meter
	Field Drain	8 83	Gas Curb Stop	ß	Railroad Rail Post	•	Warning Riser
®	Downspout	GAS	Gas Meter	×	Railroad Spike	W	Water Valve
⊕	Round Inlet	ĕ v	Gas Valve	۲	Satellite Dish	8	Yard Hydrant
ð	Stand Pipe	&	Handicap	0	Sign	\bigcirc	Post Indicator Valve
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<u>(</u>	Guy Anchor						
	CATV CATV		Underground Cable Tele	vision	— т — —		Overhead Telephone
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	UE		Underground Electric		w		Water Line
_	<u> </u>		Fence				Right-of-Way Line
(—	G		Gas Line		FOC		Fiber Optic Line

drawings and/or field markings. Utility lines shown hereon are approximate in location and intended for reference only. Call Indiana Underground Plant Protection Services (IUPPS) at 1-800-382-5544 for field marked location of utilities prior to any excavation.

I Nana A. Opoku certify that I am a Land Surveyor licensed in compliance with the laws of the State of Indiana; that to the best of my knowledge, information and belief all information shown hereon is true and accurate:

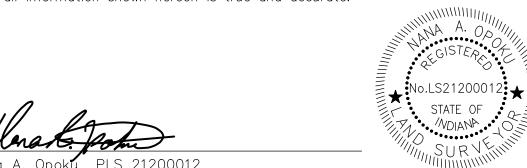

BENCHMARK INFORMATION

South Corner of concrete at clean out (See Survey Drawing) Elevation: 756.89

at clean out (See Survey Drawing)

West Corner of concrete

Elevation: 756.69

Spike set in South face of power pole (See Survey Drawing) Elevation: 750.51

Chiseled box set on Northwest corner of bottom step (See Survey Drawing) Elevation: 756.19

5/8" Steel rebar Northing: 212039.668 Easting: 473818.898 Elevation: 757.30

Northing: 2128872.695

Easting: 473767.099

Elevation: 758.41

CP-102

CP-103

5/8" Steel rebar W/Apex ID. Cap

Northing: 2128846.008

Easting: 473941.980

Elevation: 756.52

3/8" Steel rebar W/orange cap 5/8" Steel rebar W/Apex ID. Cap Northing: 2128047.709 Easting: 474308.435 Elevation: 749.16

CP-104 5/8" Steel rebar W/Apex ID. Cap

5/8" Steel rebar W/Apex ID. Cap

Northing: 2127942.834

Northing: 2128010.125

Easting: 474525.806

Elevation: 760.88

Easting: 474366.289

Elevation: 750.13

APEX Consulting & Surveying, Inc. Date of office work:

Date of fieldwork:

NAO


LAND SURVEYING LAND PLANNING & DESIGN 1313 BROADWAY FORT WAYNE, IN. 46802 PH: (260) 755-5993 FAX: (888) 808-4177
E - MAIL : info@apexsurveying.net

NANA A. OPOKU, PLS No. LS21200012 **APEX** Consulting & Surveying

TOPOGRAPHIC SURVEY

City of Fort Wayne Spy Run Creek Dam Removal Wayne Township, Allen County, Indiana

Cad File Name:		VISIONS	REVISIO
24010001.DWG	DESCRIPTION	BY DATE	BY
Sheet No.:			
1 of 1			
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W.O. NO: 83947 DWG NO: ##-####

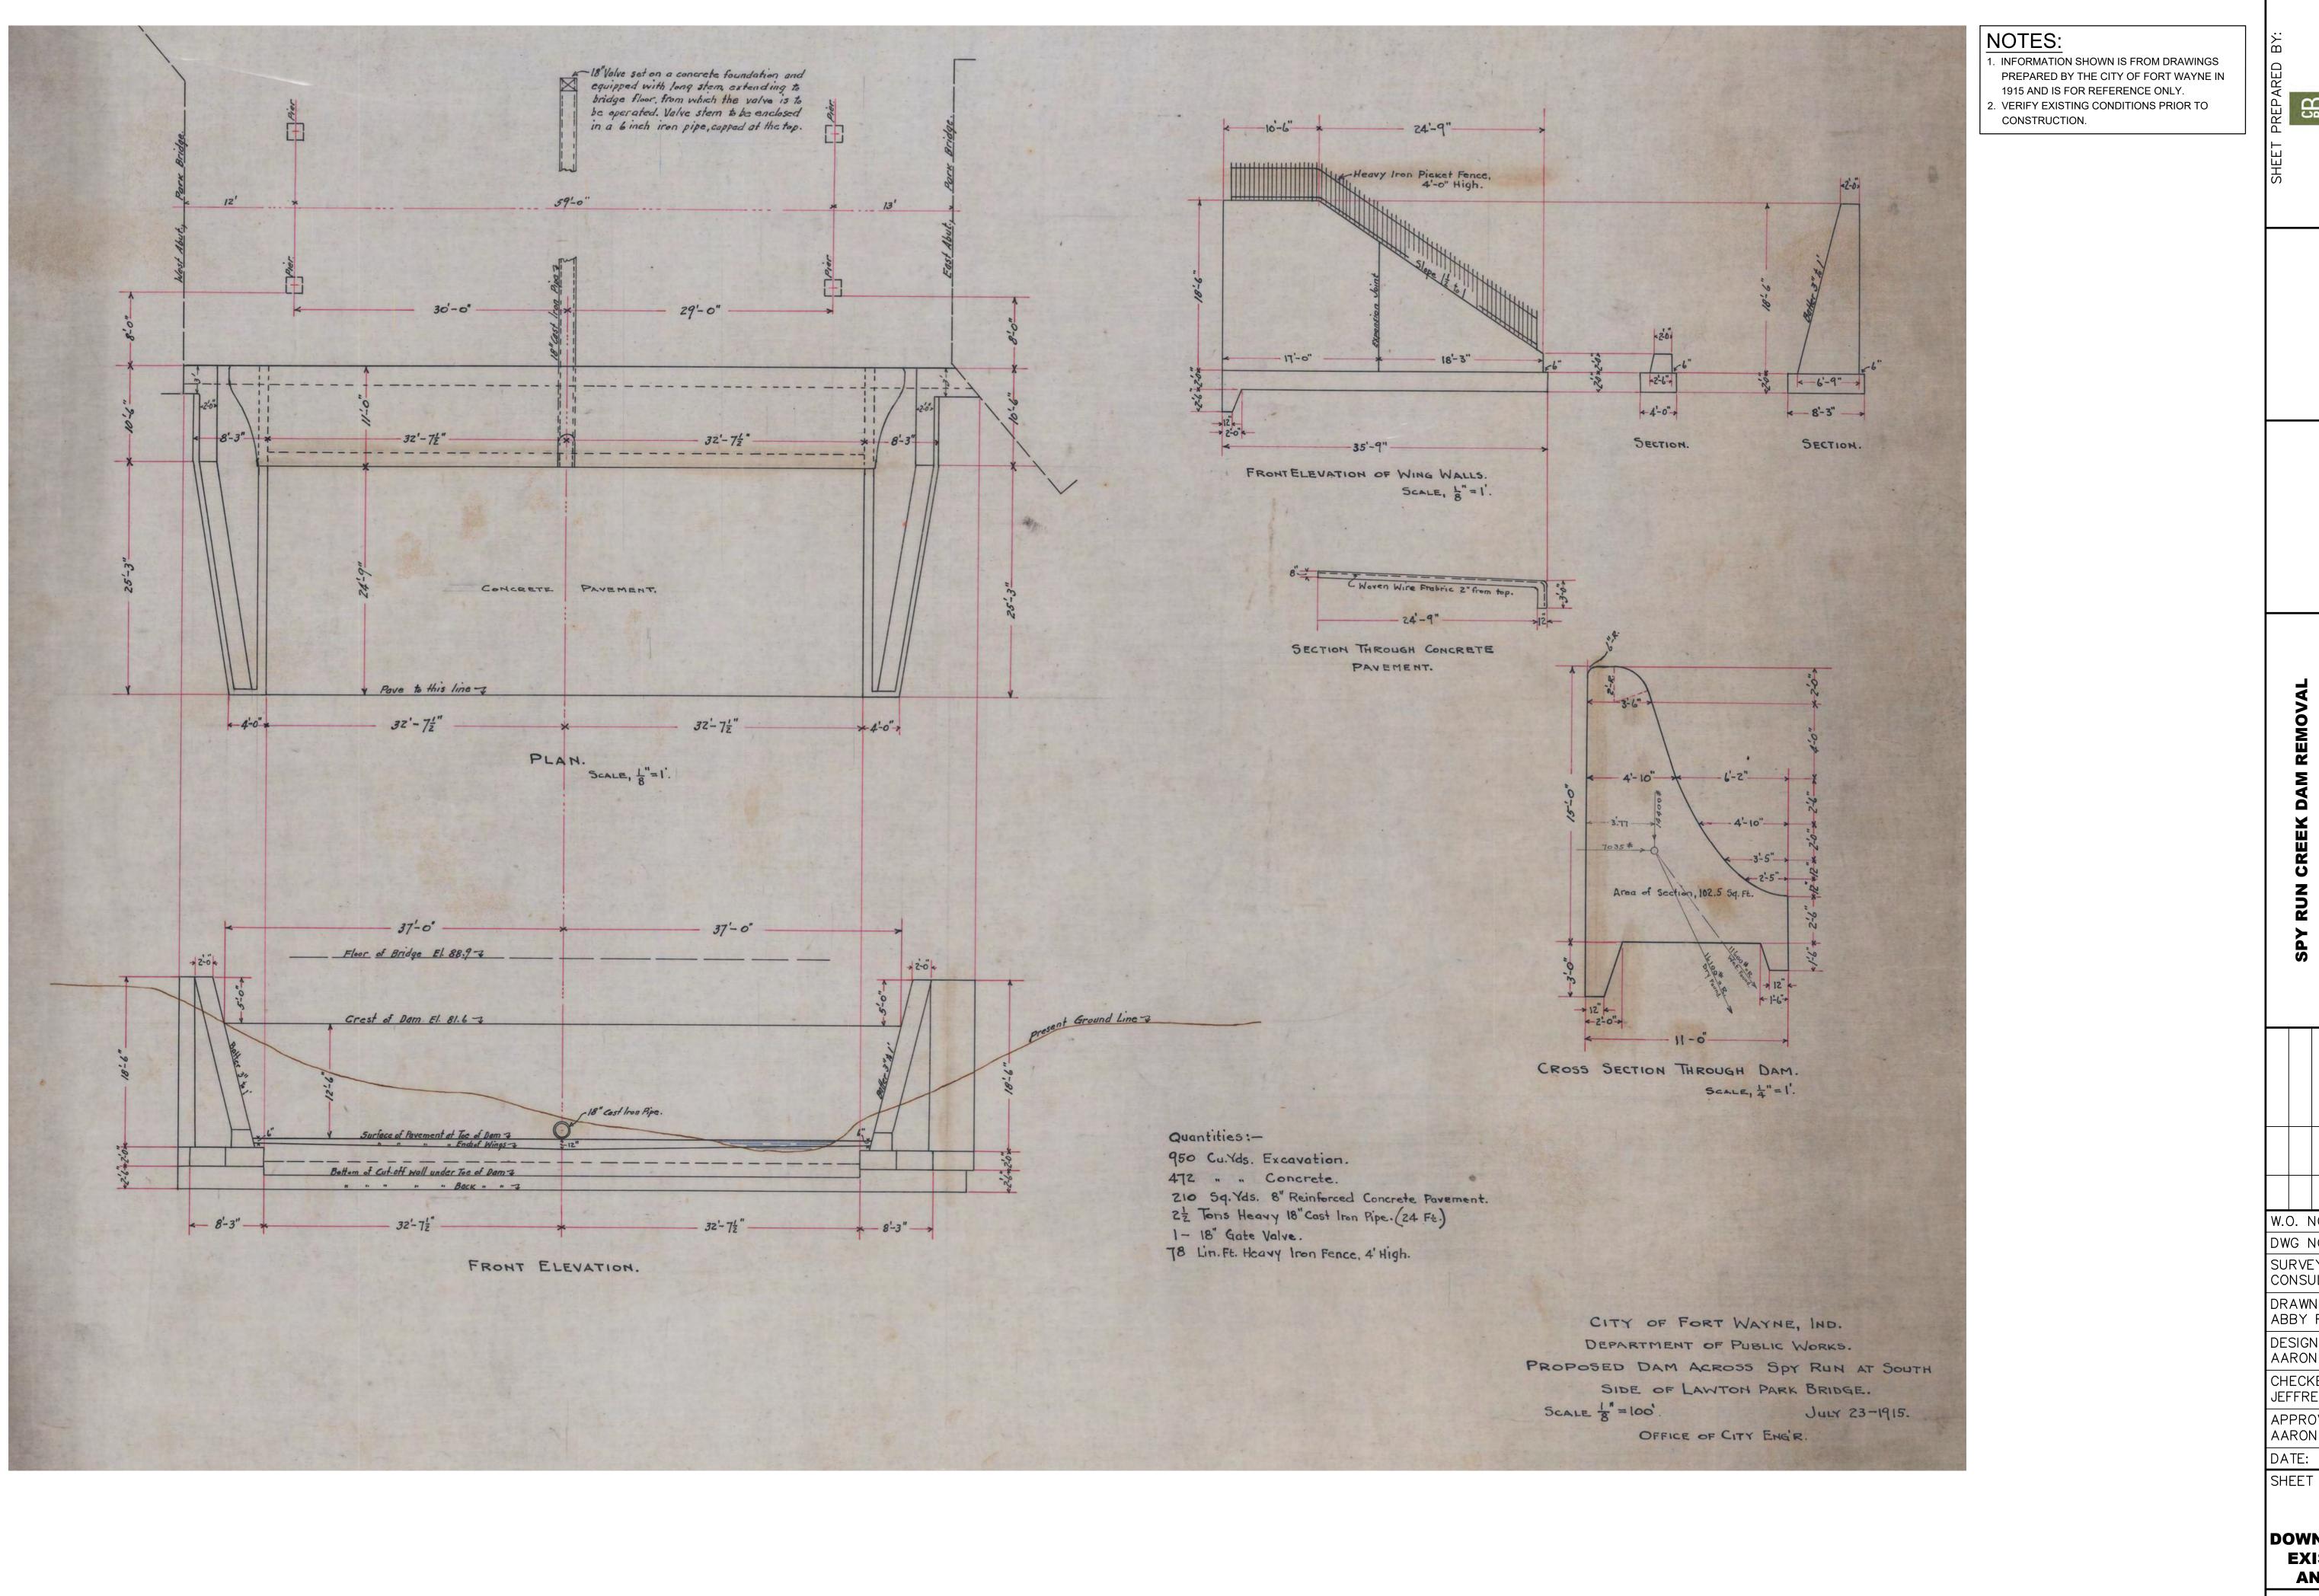SURVEYED BY: APEX CONSULTING&SURVEYING

DRAWN BY: ABBY R. PETERSON, P.E. DESIGNED BY: AARON J. FRICKE, P.E.


CHECKED BY: JEFFREY D. FOX, P.E.


APPROVED BY: AARON J. FRICKE, P.E.


SHEET TITLE:

DOWNSTREAM DAM **EXISTING PLAN AND SECTION**

G-003-004 SHEET 4 OF 10

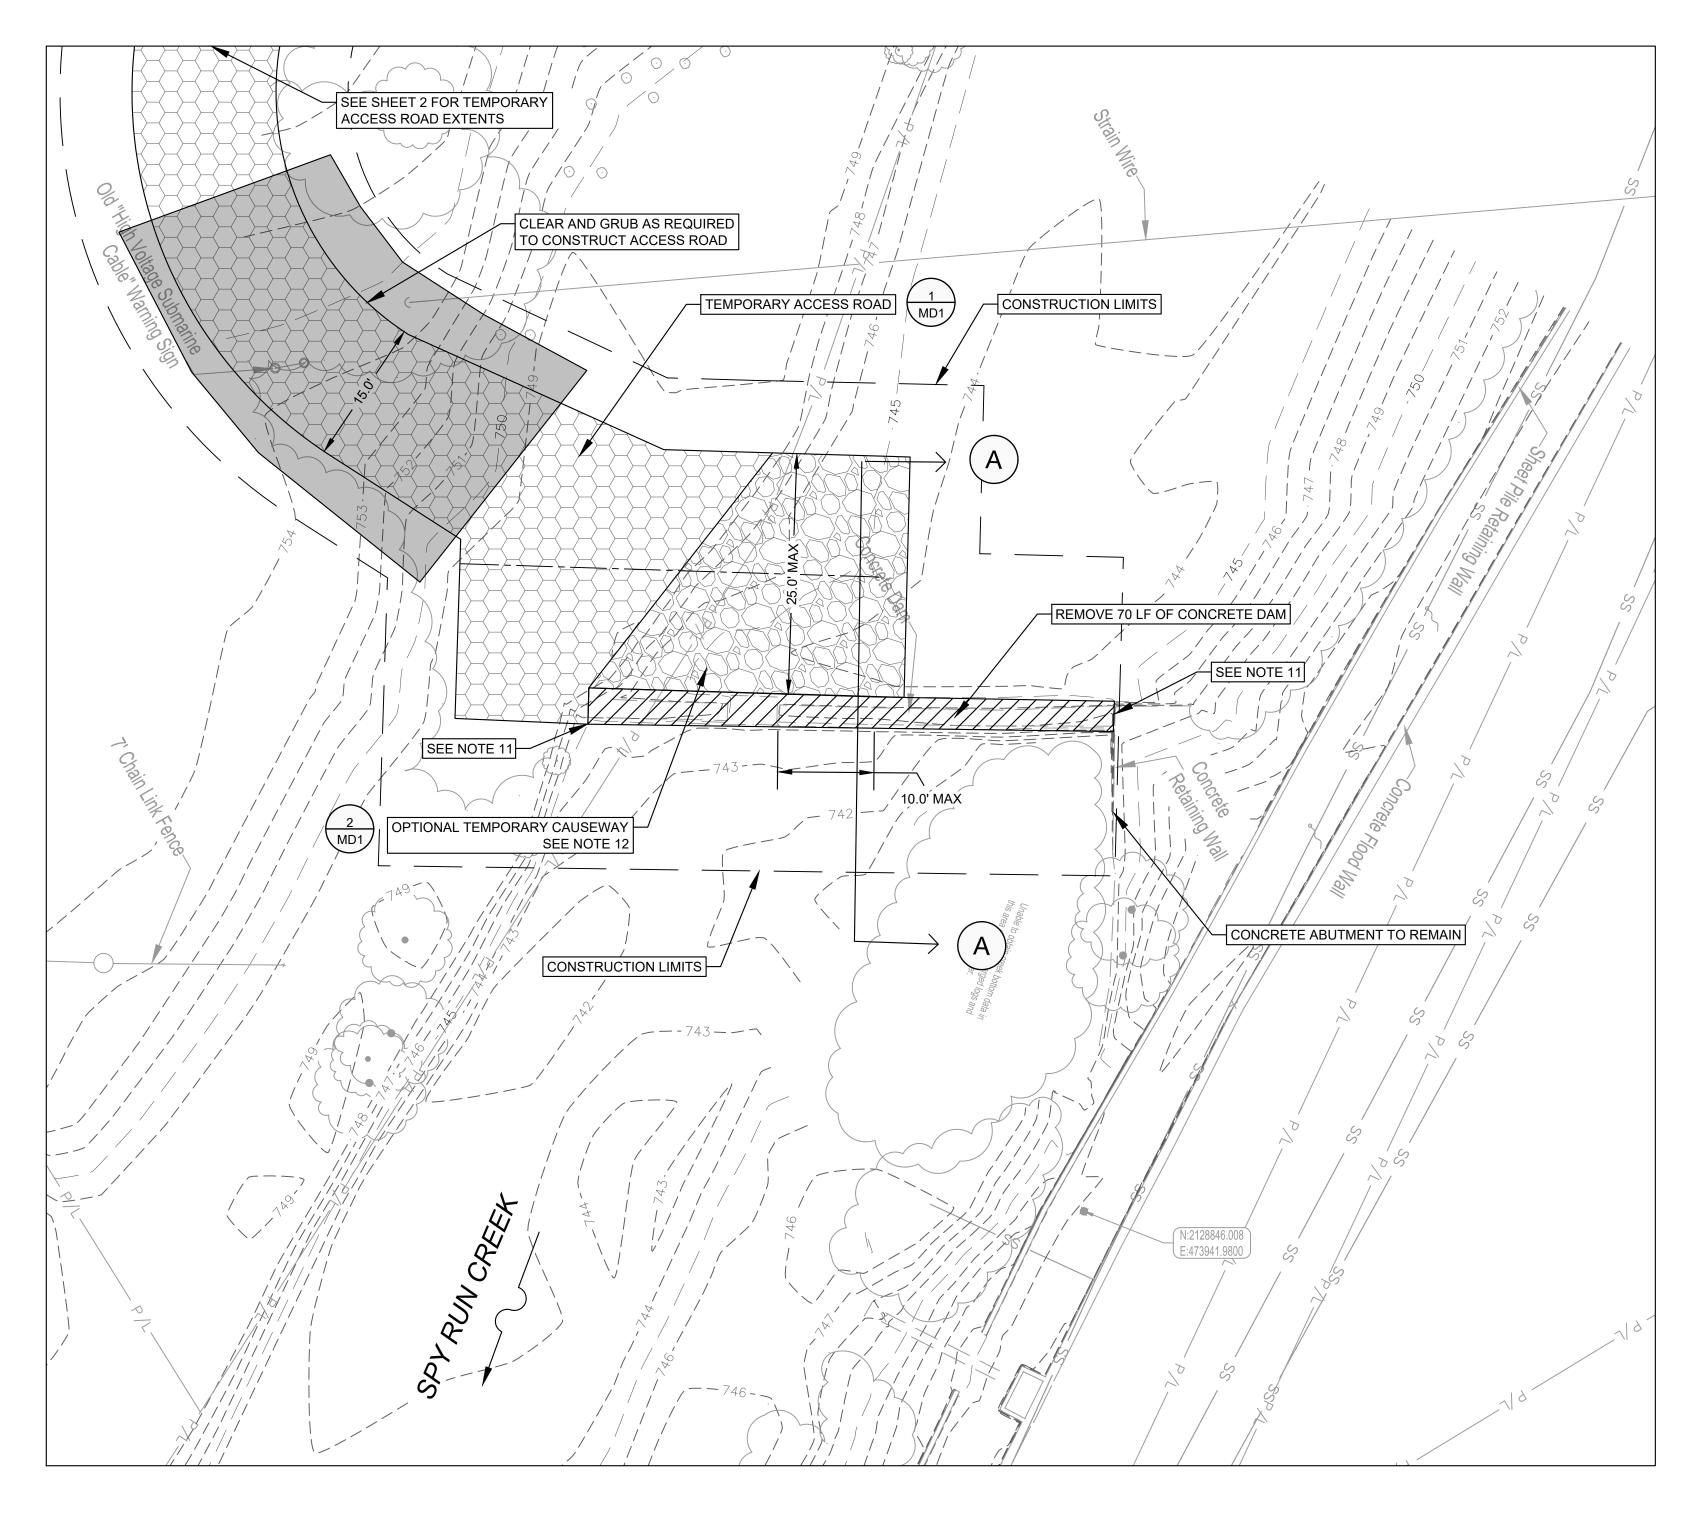


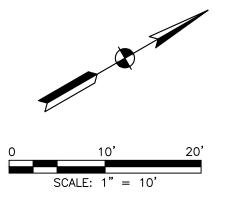

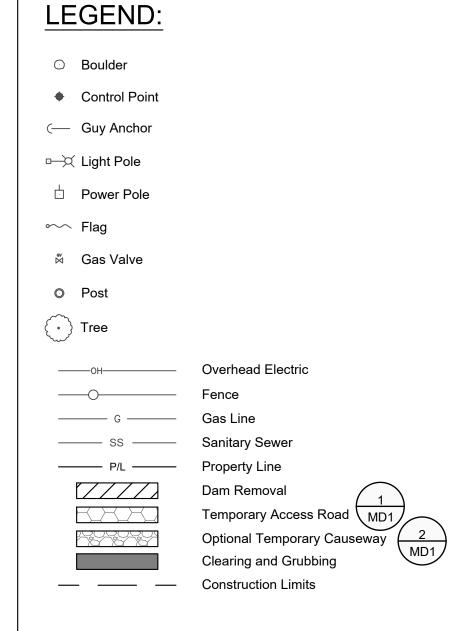

NOTES:

- TOPOGRAPHIC AND PLANIMETRIC INFORMATION IS SHOWN PER A SURVEY PERFORMED BY APEX CONSULTING & SURVEYING, INC., DATED MARCH 1, 2024.
- 2. THE BASE FLOOD ELEVATION OF SPY RUN AT THE DAM IS 757.0 FEET (NAVD 88) PER THE FEMA FLOOD INSURANCE STUDY FOR ALLEN COUNTY, INDIANA AND INCORPORATED AREAS, REVISED JANUARY 11, 2024.
- DISPOSE OF ALL CONCRETE AND RUBBLE REMOVED FROM THE EXISTING DAM AS WELL AS ANY VEGETATION REMOVED OR OTHER CONSTRUCTION DEBRIS AT AN APPROVED OFFSITE LOCATION. SUBMIT DISPOSAL SITE INFORMATION AND ANY REQUIRED PERMITTING TO ENGINEER FOR APPROVAL.
- DO NOT WORK IN THE WATERWAY FROM APRIL 1 THROUGH JUNE 30 WITHOUT PRIOR WRITTEN APPROVAL OF THE INDIANA DEPARTMENT OF NATURAL RESOURCES DIVISION OF FISH AND WILDLIFE.
- 5. DO NOT EXCAVATE WITHIN THE RIVER EXCEPT FOR REMOVAL OF THE EXISTING DAM AND SEDIMENT AS INDICATED.
- 6. TAKE APPROPRIATE MEASURES TO MINIMIZE THE MOVEMENT OF RESUSPENDED BOTTOM SEDIMENT FROM THE IMMEDIATE PROJECT AREA.
- 7. RATE OF DRAWDOWN MAY NOT EXCEED 1 FOOT PER DAY. CONTRACTOR IS RESPONSIBLE FOR SUBMITTING DETAILED SEQUENCING AND DEWATERING INFORMATION TO OWNER AND ENGINEER FOR APPROVAL. DOWNSTREAM DAM SHALL BE REMOVED FIRST.
- 8. DEWATERING DIRECTLY INTO THE RIVER IS PROHIBITED. UTILIZE DEWATERING BAGS OR OTHER APPROVED MEASURES.
- 9. DO NOT CUT ANY TREES SUITABLE FOR INDIANA BAT OR NORTHERN LONG-EARED BAT ROOSTING FROM APRIL 1 TO SEPTEMBER 30. SUCH TREES ARE GREATER THAN 3 INCHES DIAMETER AT BREAST HEIGHT, LIVING OR DEAD, WITH LOOSE HANGING BARK, OR WITH CRACKS, CREVICES, OR CAVITIES.
- 10. STABILIZE ALL BARE AND DISTURBED AREAS LANDWARD OF THE SHORELINE WITHIN ONE WEEK OF DISTURBANCE.
- 11. FIELD VERIFY CONNECTION OF DAM TO ABUTMENTS AND SUBMIT WORK PLAN TO OWNER AND ENGINEER FOR REMOVAL OF DAM AT THE ABUTMENTS. IT IS EXPECTED THAT FIELD VERIFICATION WILL OCCUR AFTER SUFFICIENT DEWATERING TAKES PLACE SUCH THAT THERE IS NO FLOW OVER THE DAM. NOTIFY OWNER AND ENGINEER PRIOR TO FIELD VERIFICATION.
- TEMPORARY CAUSEWAY IS OPTIONAL. REMOVE AT THE END OF CONSTRUCTION. NO OTHER TEMPORARY IMPACTS BELOW THE ORDINARY HIGH WATER MARK ARE ALLOWED.

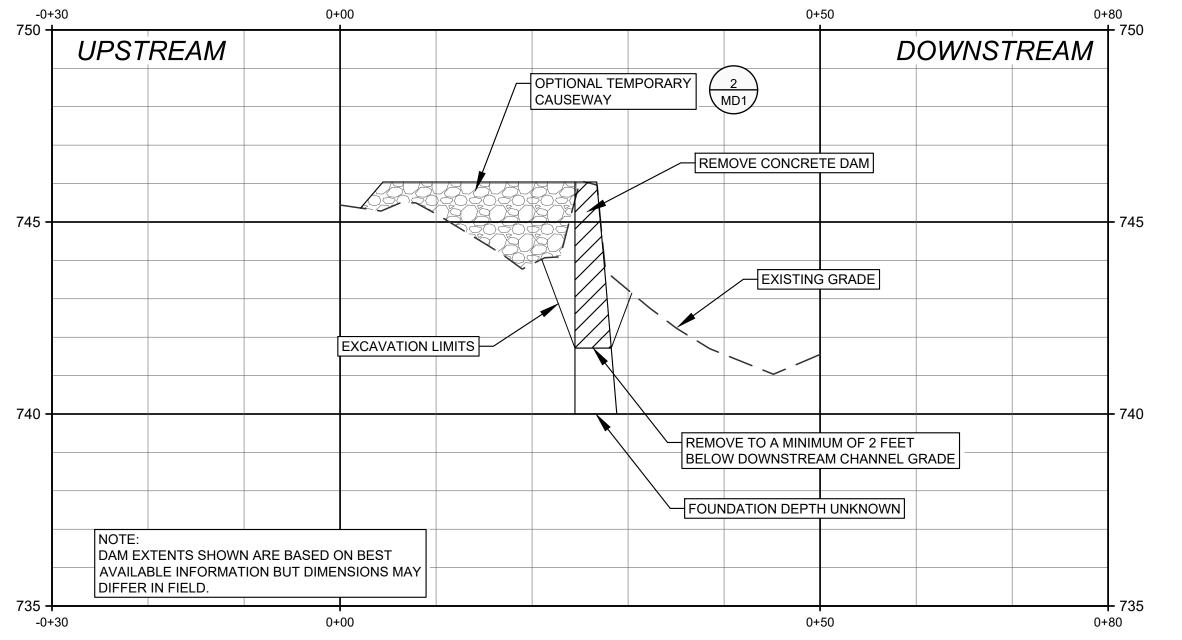

CROSS SECTION A-A

BURKE BURKE RISTOPHER B. BUR ENGINEERING, LLC CENTER, SUITE 13 W. WASHINGTON STANAPOLIS, IN 469


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G 50 BY: ____ DATE: _

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BERRY ST., STE

FORT WA CITY UTIL

30% PLANS
NOT FOR
CONSTRUCTION

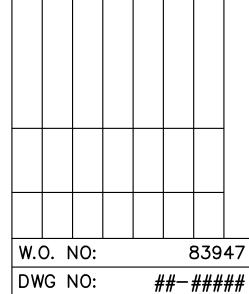

DWG NO: ##-####

SURVEYED BY: APEX
CONSULTING&SURVEYING

DRAWN BY:
ABBY R. PETERSON, P.E.
DESIGNED BY:
AARON J. FRICKE, P.E.


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JEFFREY D. FOX, P.E.


APPROVED BY:
AARON J. FRICKE, P.E.
DATE:

SHEET TITLE:


SITE PLAN -UPSTREAM DAM REMOVAL


C-101-005 SHEET 5 OF 10

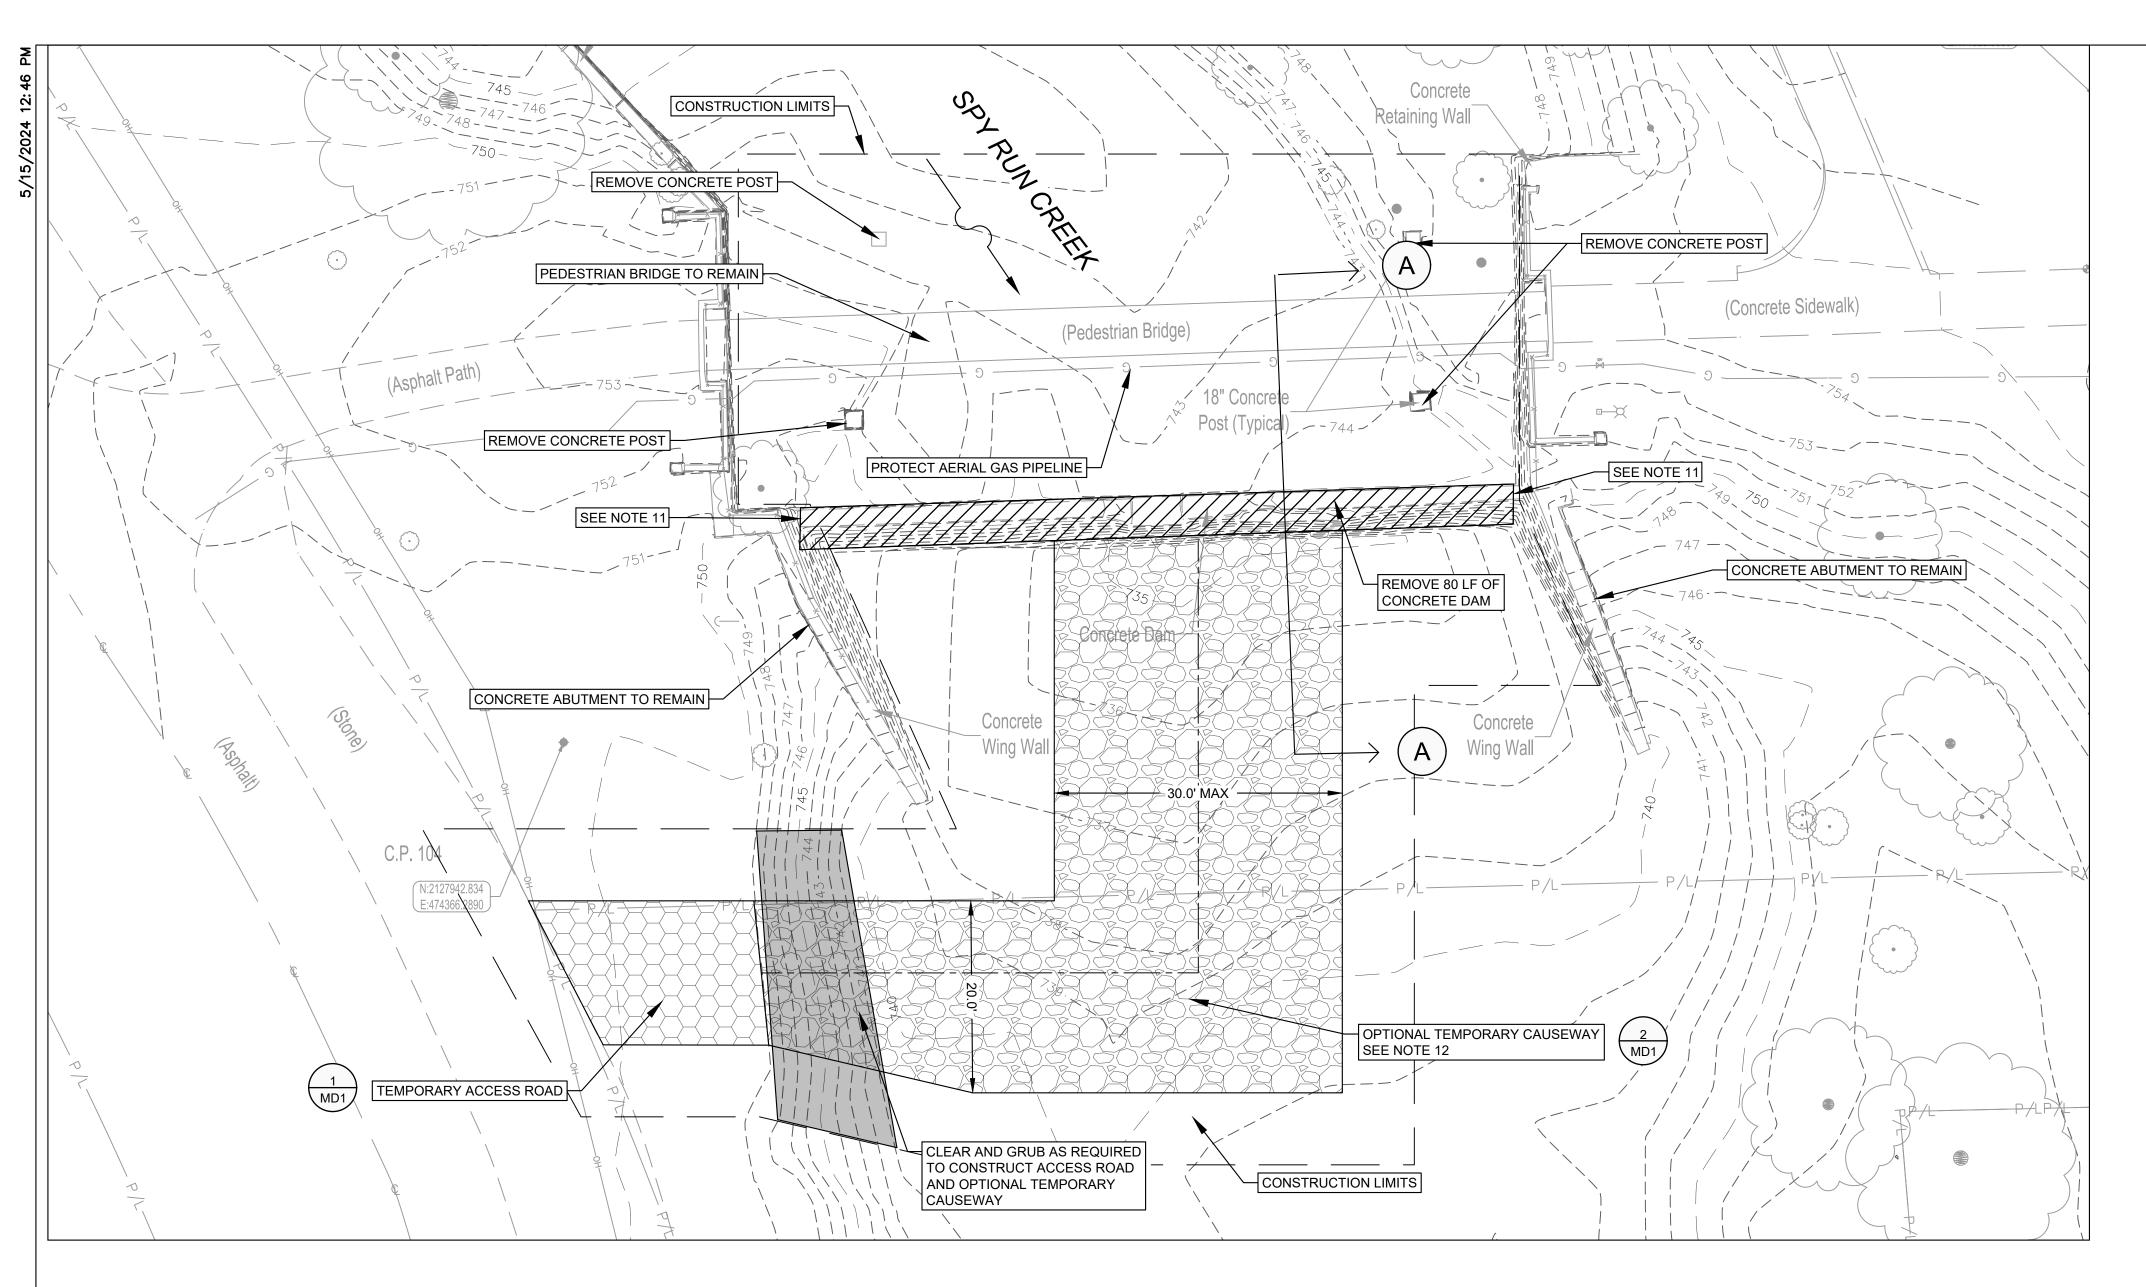

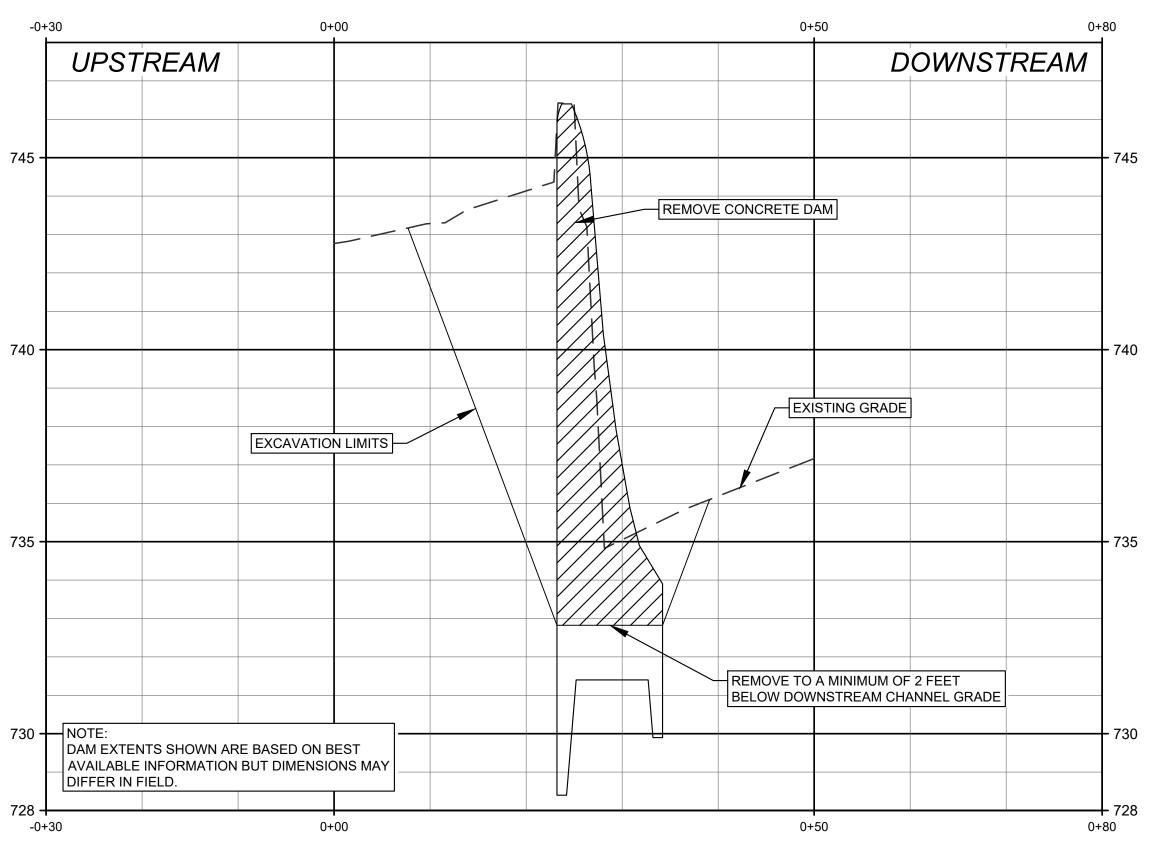

CROSS SECTION A-A

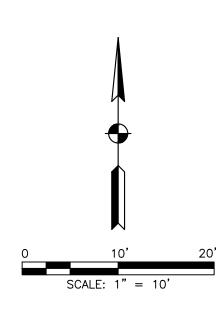

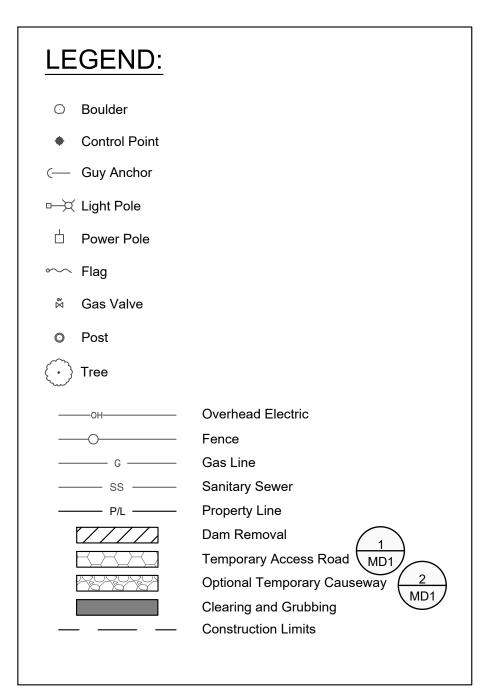

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CHRISTOPHER B. BURKE ENGINEERING, LLC IC CENTER, SUITE 1368 N. WASHINGTON STRE NDIANAPOLIS, IN 46204

BY:______

EPARED FOR:


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Y UTILITIES ENGINEERIN

ZENS SQUARE

D E. BERRY ST., STE 2

30% PLANS
NOT FOR
ONSTRUCTION

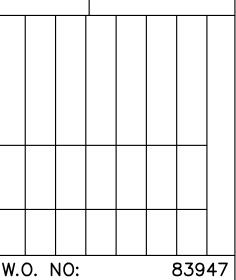

W.O. NO: 83947

DWG NO: ##-####

SURVEYED BY: APEX

DRAWN BY:
ABBY R. PETERSON, P.E.


DESIGNED BY:
AARON J. FRICKE, P.E.
CHECKED BY:
JEFFREY D. FOX, P.E.


APPROVED BY:
AARON J. FRICKE, P.E.
DATE:

SHEET TITLE:

SITE PLAN -DOWNSTREAM DAM REMOVAL


C-102-006 SHEET 6 OF 10

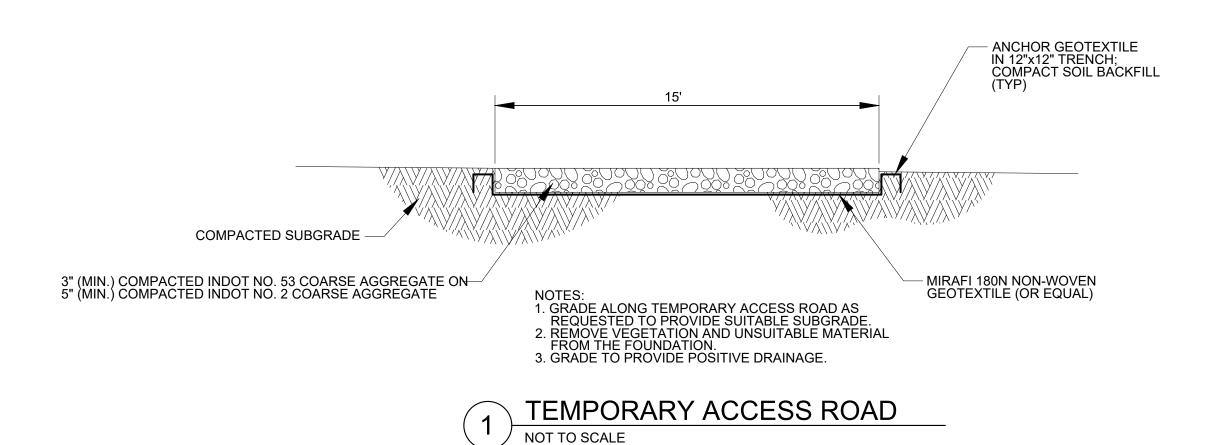

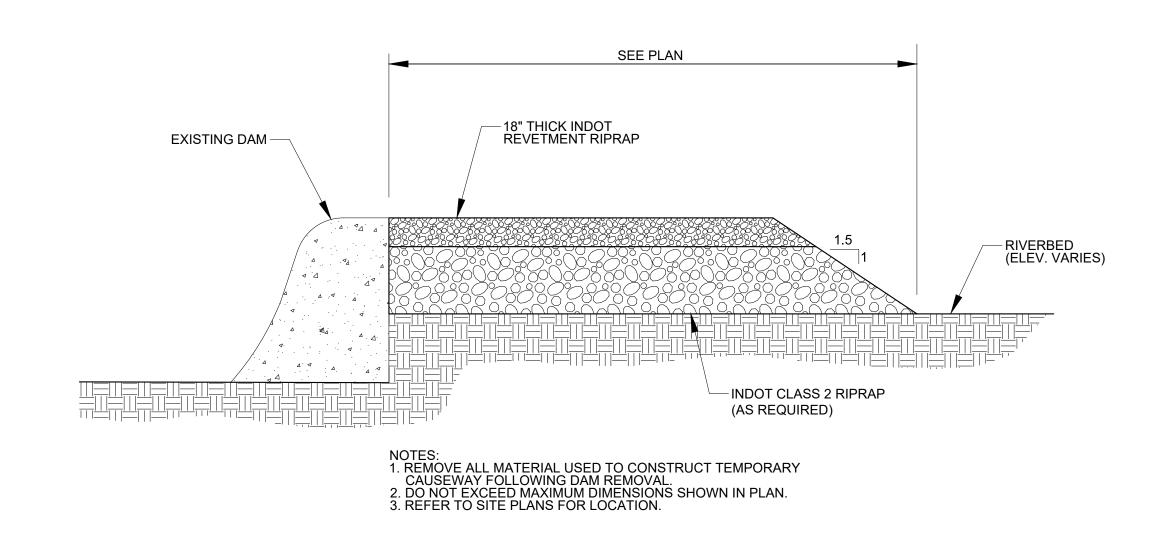

OPTIONAL UPSTREAM TEMPORARY CAUSEWAY

NOT TO SCALE

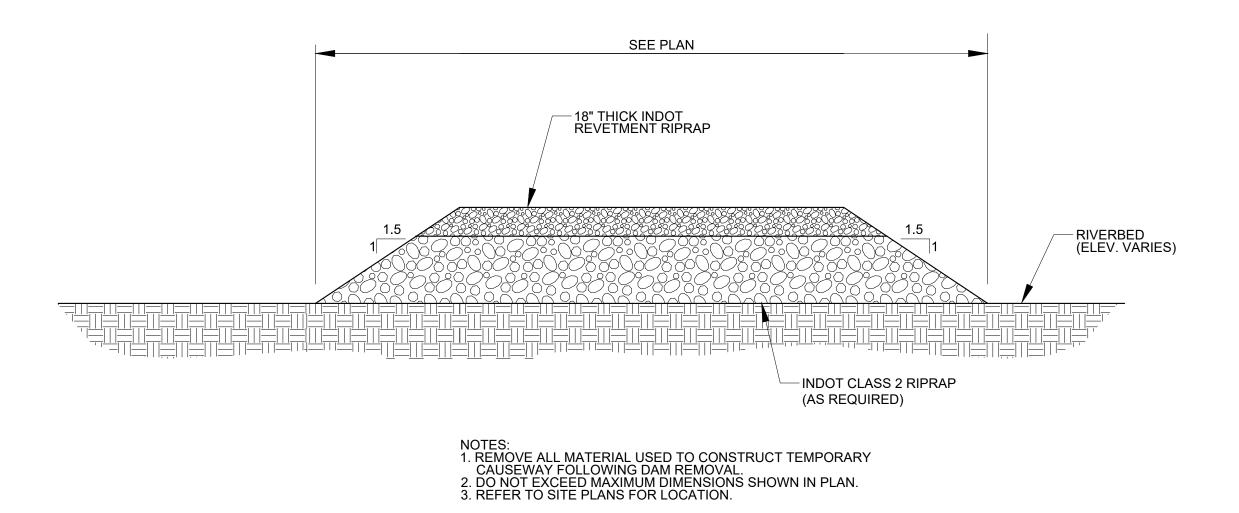


OPTIONAL DOWNSTREAM TEMPORARY CAUSEWAY

NOT TO SCALE

NOT FOR CONSTRUCTION 83947 W.O. NO: DWG NO: ##-#### SURVEYED BY: APEX CONSULTING&SURVEYING DRAWN BY: ABBY R. PETERSON, P.E. DESIGNED BY: AARON J. FRICKE, P.E. CHECKED BY: JEFFREY D. FOX, P.E. APPROVED BY: AARON J. FRICKE, P.E. DATE: SHEET TITLE: **MISCELLANEOUS DETAILS**

C-103-007

SHEET 7 OF

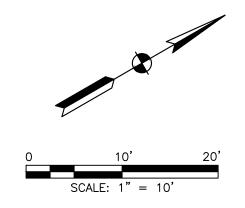

GENERAL NOTES:

- 1. TOPOGRAPHIC AND PLANIMETRIC INFORMATION IS SHOWN PER A SURVEY PERFORMED BY APEX CONSULTING & SURVEYING, INC., DATED MARCH 1, 2024.
- 2. THE BASE FLOOD ELEVATION OF SPY RUN AT THE DAM IS 757.0 FEET (NAVD 88) PER THE FEMA FLOOD INSURANCE STUDY FOR ALLEN COUNTY, INDIANA AND INCORPORATED AREAS, REVISED JANUARY 11, 2024.

EROSION CONTROL NOTES:

- 1. TEMPORARY EROSION CONTROL FEATURES TO HELP PREVENT SEDIMENT FROM LEAVING THE SITE ARE SHOWN AT APPROXIMATE LOCATIONS.
- 2. INSPECT EROSION CONTROL FEATURES AT LEAST WEEKLY AND AGAIN WITHIN 24 HOURS FOLLOWING EACH RAINFALL EVENT OF 0.5 INCH OR MORE. REMOVE ACCUMULATED SEDIMENT IMMEDIATELY. REPAIR OR REPLACE DAMAGED EROSION CONTROL FEATURES IMMEDIATELY.
- 3. ROUTINELY REMOVE CONSTRUCTION DEBRIS AND WASTE FROM THE SITE.
- 4. THE DURATION OF TIME WHICH AN AREA REMAINS EXPOSED SHALL BE KEPT TO A PRACTICAL MINIMUM. TEMPORARY OR PERMANENT SURFACE STABILIZATION IS REQUIRED ON ANY BARE OR THINLY VEGETATED AREA THAT IS SCHEDULED TO OR LIKELY TO REMAIN INACTIVE FOR 15 OR MORE DAYS.
- 5. DEWATERING DIRECTLY INTO THE RIVER IS PROHIBITED. UTILIZE DEWATERING BAGS OR OTHER MEASURES APPROVED BY ENGINEER AND OWNER.
- 6. MAINTAIN EROSION CONTROL MEASURES THROUGHOUT CONSTRUCTION AS DESCRIBED ON THE DRAWINGS
- 7. REMOVE ACCUMULATED SEDIMENT FROM THE SITE AFTER PERMANENT VEGETATION IS ESTABLISHED AND DISPOSE OFFSITE.
- 8. COORDINATE ACCEPTABLE LOCATION FOR STAGING AND STOCKPILING WITH OWNER IN ACCORDANCE WITH PERMIT CONDITIONS.
- 9. INSTALL EROSION CONTROL BLANKET IN ALL AREAS TO BE SEEDED THAT ARE 4:1 (H:V) OR STEEPER.

GENERAL CONSTRUCTION SEQUENCE:


THE GENERAL CONSTRUCTION SEQUENCE HAS BEEN PREPARED FOR PROJECT GUIDANCE AND MAY BE ADJUSTED TO MEET CONTRACTOR'S SPECIFIC PLANS. HOWEVER, THE SEQUENCE OF STEPS 1-3 MAY NOT BE ALTERED. CONTRACTOR SHALL GENERALLY PERFORM THE FOLLOWING STEPS TO COMPLETE THE PROJECT.

- 1. STAKE THE LIMITS OF CONSTRUCTION.
- 2. INSTALL EROSION CONTROL MEASURES PRIOR TO LAND DISTURBING ACTIVITIES, INCLUDING INITIAL PERIMETER CONTROL.
- 3. CONSTRUCT A TEMPORARY ACCESS ROAD(S) TO THE DAM.
- 4. CONSTRUCT TEMPORARY CAUSEWAY.
- 5. REMOVE THE DAM.
- 6. REMOVE THE TEMPORARY CAUSEWAY.
- 7. REMOVE THE TEMPORARY ACCESS ROAD(S).
- 8. STABILIZE DISTURBED AREAS WITH TEMPORARY OR PERMANENT SEEDING AS SOON AS POSSIBLE WHEN WORK IS COMPLETE.
- 9. THROUGHOUT CONSTRUCTION, CONTROL DUST ON THE PROJECT SITE. SWEEP STREETS AS NECESSARY TO KEEP CLEAN OF DIRT, DUST, AND CONSTRUCTION DEBRIS. PROPERLY DISPOSE OF ALL CLEARED MATERIAL.
- REMOVE ALL TEMPORARY CONTROL MEASURES UPON APPROVAL OF OWNER AND ENGINEER AND SUCCESSFUL ESTABLISHMENT OF VEGETATION AND PROJECT COMPLETION.

CHRISTOPHER B. BURKE
ENGINEERING, LLC
PNC CENTER, SUITE 1368 S
115 W. WASHINGTON STREET
INDIANAPOLIS, IN 46204
PHONE: (317) 266-8000

PREPARED FOR:
FORT WAYNE
CITY UTILITIES ENGIT
CITIZENS SQUARE

30% PLANS
NOT FOR
ONSTRUCTION

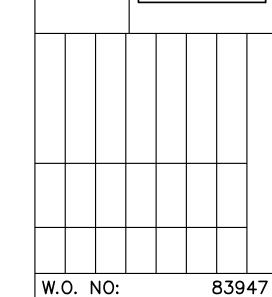

DWG NO: ##-####

SURVEYED BY: APEX

CONSULTING&SURVEYING
DRAWN BY:

ABBY R. PETERSON, P.E.

DESIGNED BY:


AARON J. FRICKE, P.E.
CHECKED BY:
JEFFREY D. FOX, P.E.

APPROVED BY:
AARON J. FRICKE, P.E.
DATE:

SHEET TITLE:

EROSION CONTROL PLAN -UPSTREAM DAM

> C-104-008 SHEET 8 OF 10

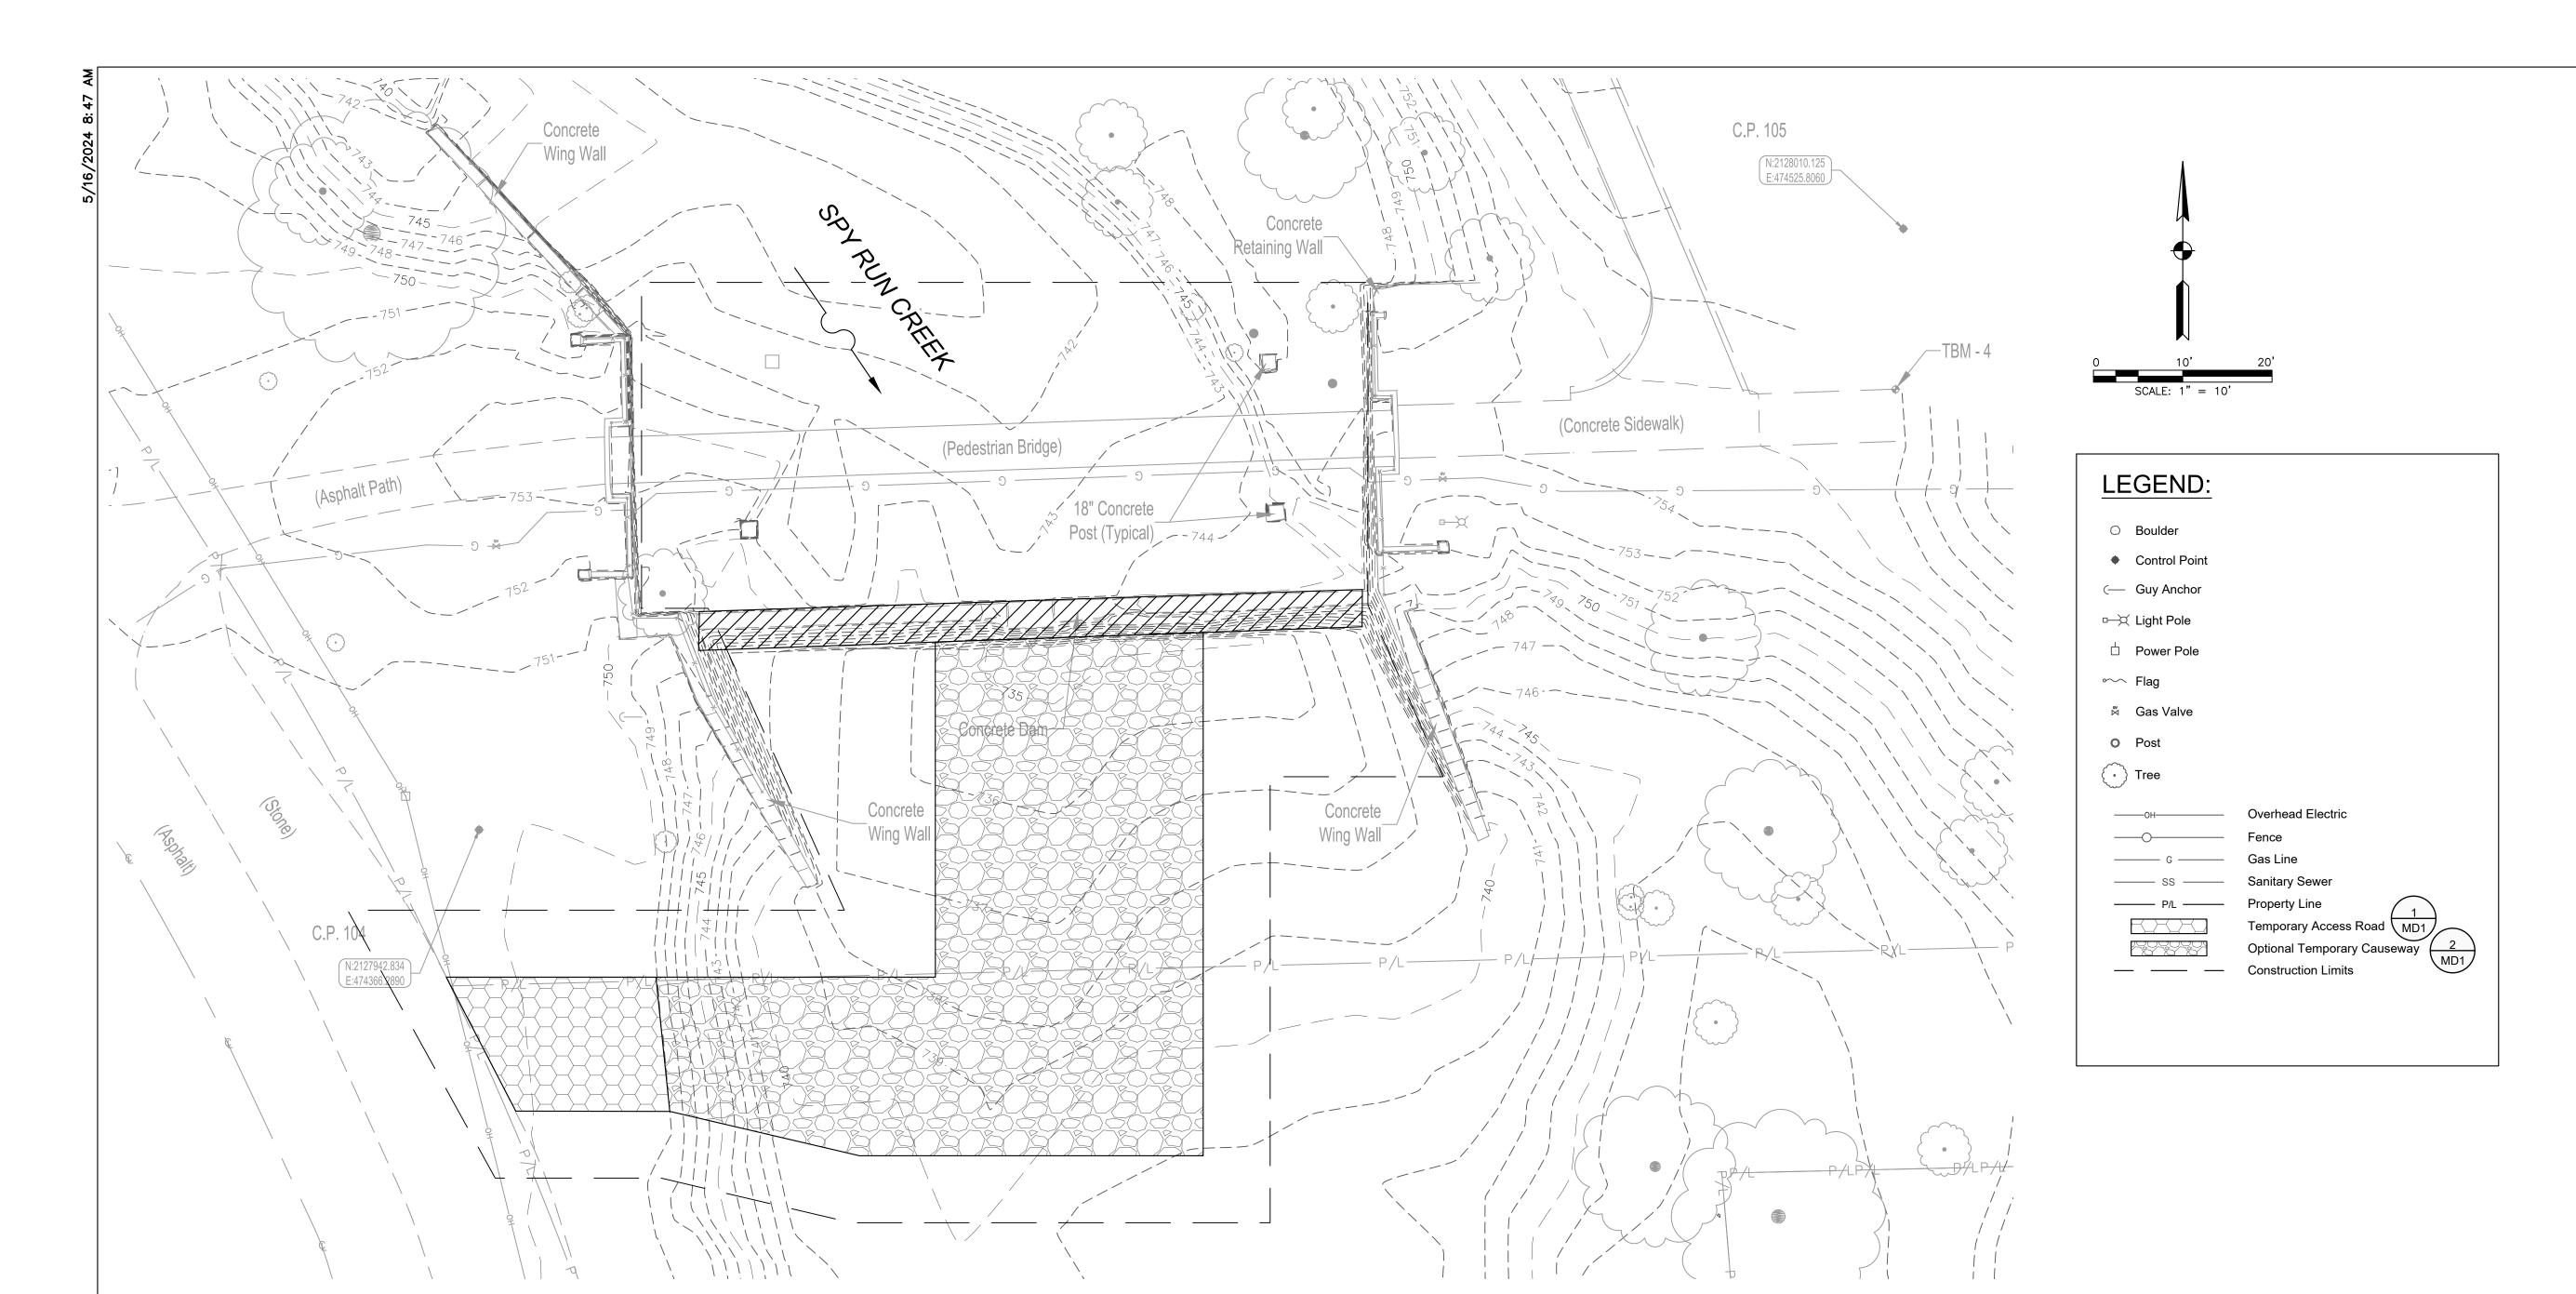

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EROSION CONTROL NOTES:

ACCORDANCE WITH PERMIT CONDITIONS.

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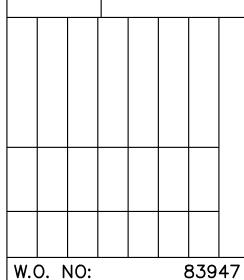
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- 10. REMOVE ALL TEMPORARY CONTROL MEASURES UPON APPROVAL OF OWNER AND ENGINEER AND SUCCESSFUL ESTABLISHMENT OF VEGETATION AND PROJECT COMPLETION.

CHRISTOPHER B. BURKE ENGINEERING, LLC PNC CENTER, SUITE 1368 S 115 W. WASHINGTON STREET INDIANAPOLIS, IN 46204

FORT WAYNE CITY UTILITIES ENGINE CITZENS SQUARE

30% PLANS
NOT FOR
ONSTRUCTION



DWG NO: ##-####

SURVEYED BY: APEX
CONSULTING&SURVEYING

DRAWN BY:
ABBY R. PETERSON, P.E.
DESIGNED BY:


CHECKED BY:
JEFFREY D. FOX, P.E.


APPROVED BY:
AARON J. FRICKE, P.E.
DATE:

SHEET TITLE:

PLAN DOWNSTREAM DAM

C-105-009 SHEET ⁹ OF 10

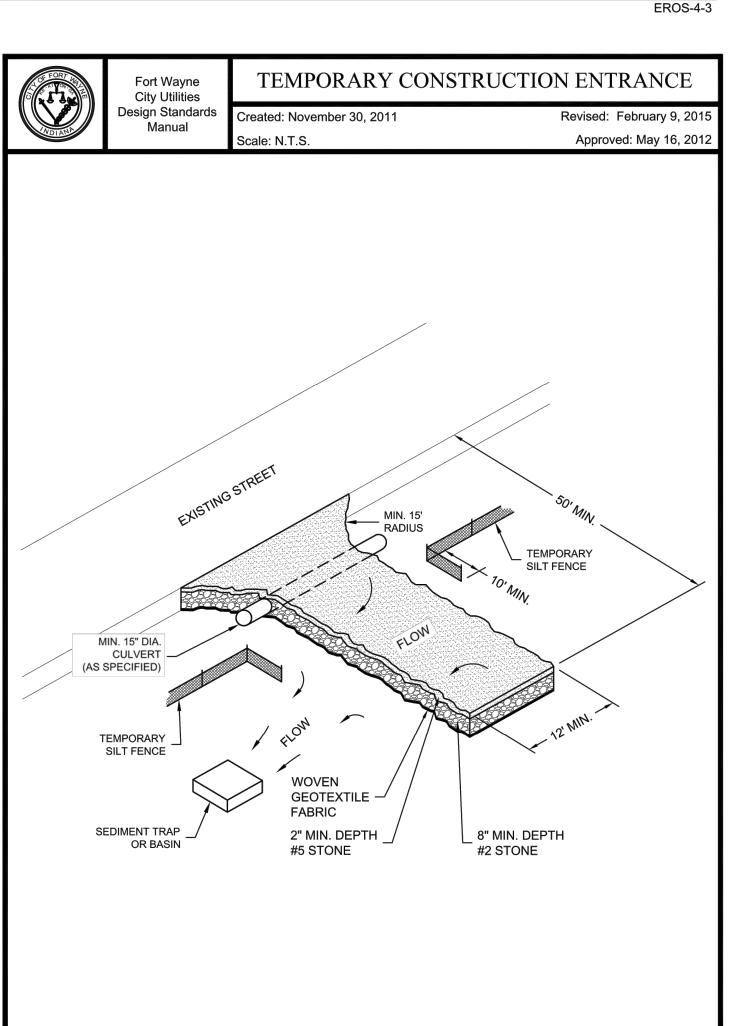

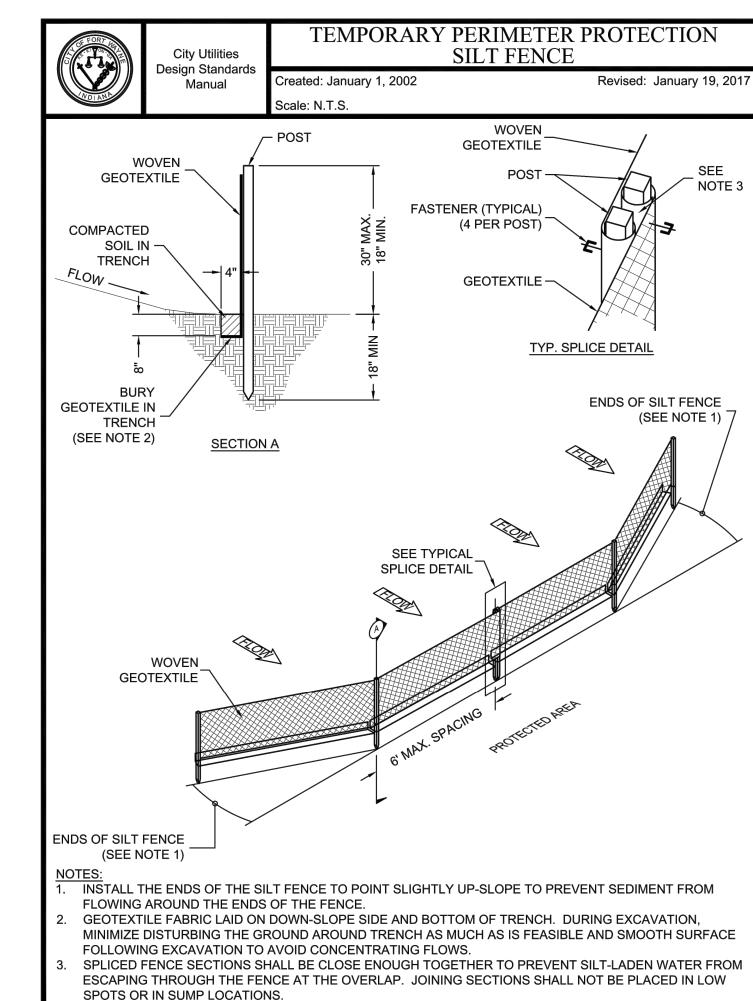

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STABILIZATION PRACTICE	JAN	 FEB	 MAR	 APR	 MAY	 JUN	JUL	AUG	 SEP	OCT	NOV	l DE
PERMANENT SEEDING		 	Α —	-	① *///////	V///		(10) *	*///> <u> </u>	 		
DORMANT SEEDING		 	 	 	 	 	 	 	 	 	В	
TEMPORARY SEEDING	c—			-	*////////	<i>γ</i> ////		 * -	С	-	†	
MULCHING	D	-				 	 			 		

SEEDING NOTES:

1. FOR BEST RESULTS: (A) LEGUME SEED SHOULD BE INNOCULATED; (B) SEEDING MIXTURES CONTAINING LEGUMES SHOULD PREFERABLY BE SPRING-SEEDED, ALTHOUGH THE GRASS MAY BE FALL-SEEDED, AND (C) IF LEGUMES ARE FALL-SEEDED, DO SO IN EARLY FALL.

2. AN OAT OR WHEAT COMPANION OR NURSE CROP MAY BE USED WITH ANY OF THE PERMANENT SEEDING MIXTURES; SEE "A", THIS SCHEDULE. IF SO, IT IS BEST TO SEED DURING THE FALL SEEDING PERIOD, ESPECIALLY AFTER SEPT. 15

A = CANADA WILDRYE 6 LBS. /ACRE VIRGINIA WILDRYE 6 LBS. /ACRE 65 LBS. /ACRE PERENNIAL RYEGRASS JASPER RED FESCUE 10 LBS, /ACRE LADINO CLOVER 1 TO 2 LBS. /ACRE B = ADD 50% MORE SEED TO MIXTURES IN "A" ABOVE

C = ANNUAL RYEGRASS 60 LBS. /ACRE OATS (SPRING) 150 LBS. /ACRE

150 LBS. /ACRE D = STRAW MULCH 2 1/2 TONS/ACRE WITH LIQUID BINDER

/// = IRRIGATION NEEDED DURING JUNE, JULY AND/OR SEPTEMBER

** = IRRIGATION NEEDED FOR 2 TO 3 WEEKS AFTER APPLYING SOD

TEMPORARY VEGETATION

PLANT SPECIES SHALL BE SELECTED ON THE BASIS OF QUICK GERMINATION, GROWTH, AND TIME OF YEAR. SEEDING SHOULD BE DONE AS OFTEN AS POSSIBLE FOLLOWING CONSTRUCTION ACTIVITY. DAILY SEEDING OR ROUGH GRADED AREAS WHEN THE SOIL IS LOOSE AND MOIST IS USUALLY MOST EFFECTIVE.

INSTALLATION:
TEMPORARY SEED BED PREPARATION: A. TEST SOIL TO DETERMINE ITS NUTRIENT LEVELS. B. FERTILIZE AS RECOMMENDED BY SOIL TESTING. IF TESTING IS NOT DONE, APPLY 400-600 LBS/ACRE OF 12-12-12 ANALYSIS, OR EQUIVALENT, FERTILIZER.

C. WORK THE FERTILIZER INTO THE SOIL 2-4" DEEP WITH A DISC OR RAKE OPERATED ACROSS

TEMPORARY SEEDING:

A. USE TEMPORARY SEED MIXTURE AS SPECIFIED ON PLANS. B. APPLY SEED UNIFORMLY WITH A DRILL OR CULTIPACKER-SEEDER OR BY BROADCASTING, AND COVER TO THE APPROPRIATE DEPTH FOR THE SEED USED. C. IF DRILLING OR BROADCASTING, FIRM THE SEEDBED WITH A ROLLER OR CULTIPACKER. D. MULCH SEEDED AREA TO INCREASE SEEDING SUCCESS. ANCHOR ALL MULCH BY TACKIFYING.

MAINTENANCE:
INSPECT PERIODICALLY AFTER PLANTING TO ENSURE THAT VEGETATIVE STANDS ARE ADEQUATELY ESTABLISHED; RESEED IF NECESSARY. CHECK FOR EROSION DAMAGE AFTER STORM EVENT AND REPAIR; RESEED AND MULCH IF NECESSARY.

PERMANENT VEGETATION

REQUIREMENTS:
PLANT SPECIES SHALL BE SELECTED ON THE BASIS OF SOIL TYPE, SOIL PH, REGION OF THE STATE, TIME OF YEAR, AND PLANNED USE OF THE AREA TO BE SEEDED.

INSTALLATION:
PERMANENT SEED BED PREPARATION:

A. TEST SOIL TO DETERMINE PH AND NUTRIENT LEVELS. B. IF SOIL PH IS UNSUITABLE FOR THE SPECIES TO BE SEEDED, APPLY LIME ACCORDING TO TEST RECOMMENDATIONS.

C. TILL THE SOIL TO OBTAIN A UNIFORM SEEDBED, WORKING THE FERTILIZER AND LIME INTO THE SOIL 2-4" DEEP WITH A DISC OR RAKE OPERATED ACROSS THE SLOPE.

PERMANENT SEEDING:

OPTIMUM SEEDING DATES ARE MARCH 1 THROUGH MAY 10 AND AUGUST 10 THROUGH SEPTEMBER 30. PERMANENT SEEDING DONE BETWEEN MAY 10 AND AUGUST 10 MAY NEED TO BE IRRIGATED. AS AN ALTERNATIVE, USE TEMPORARY SEEDING UNTIL THE PREFERRED DATE FOR PERMANENT SEEDING.

A. USE SEED MIX A AS SPECIFIED ON PLANS. B. APPLY SEED UNIFORMLY WITH A HYDROSEEDER, DRILL OR CULTIPACKER-SEEDER, OR BY

BROADCAST, AND COVER TO A DEPTH OF 1/4 TO 1/2". C. IF DRILLING OR BROADCASTING, FIRM THE SEEDBED WITH A ROLLER OR CULTIPACKER. D. MULCH ALL SEEDED AREAS AND ANCHOR WITH A TACKIFYER.

MAINTENANCE:
INSPECT PERIODICALLY, ESPECIALLY AFTER STORM EVENTS, UNTIL THE STAND IS SUCCESSFULLY ESTABLISHED (CHARACTERISTICS OF A SUCCESSFUL STAND INCLUDE: VIGOROUS DARK GREEN OR BLUE-ISH GREEN SEEDINGS; UNIFORM DENSITY WITH NURSE PLANTS, LEGUMES, AND GRASSES WELL INTERMIXED; AND THE PERENNIALS REMAINING GREEN THROUGHOUT THE SUMMER, AT LEAST AT THE PLANT BASE). ADD FERTILIZER THE FOLLOWING GROWING SEASON ACCORDING TO SOIL TEST RECOMMENDATION, REPAIR DAMAGED, BARE OR SPARSE AREAS BY FILLING ANY GULLIES, REFERTILIZING, OVER- OR RESEEDING. IF PLANT COVER IS SPARSE OR PATCHY, REVIEW THE PLANT MATERIAL CHOSEN, SOIL FERTILITY, MOISTURE CONDITION, AND MULCHING; THEN REPAIR THE AFFECTED AREA EITHER BY OVER-SEEDING OR RESEEDING AND MULCHING AFTER RE-PREPARING THE SEEDBED. IF VEGETATION FAILS TO GROW, PERFORM SOIL TESTING TO DETERMINE ACIDITY OR NUTRIENT DEFICIENCY PROBLEMS. IF ADDITIONAL FERTILIZATION IS NEEDED TO GET A SATISFACTORY STAND, DO SO ACCORDING TO SOIL TEST RECOMMENDATIONS.

SEEDING NOTES AND SCHEDULE

NOT TO SCALE

W.O. NO: DWG NO: SURVEYED BY: APEX CONSULTING&SURVEYING DRAWN BY: ABBY R. PETERSON, P.E. APPROVED BY:

83947 ##-####

DESIGNED BY: AARON J. FRICKE, P.E.

CHECKED BY: JEFFREY D. FOX, P.E.

> AARON J. FRICKE, P.E. DATE:

SHEET TITLE:

EROSION CONTROL PLAN -**DETAILS**

> C-201-010 SHEET 10 OF